
# PRELIMINARY AND FINAL SITE PLAN WITH VARIANCES

107-111 BASSETT HIGHWAY BLOCK 1201 LOT 6.01 TOWN OF DOVER MORRIS COUNTY

# NEW JERSEY

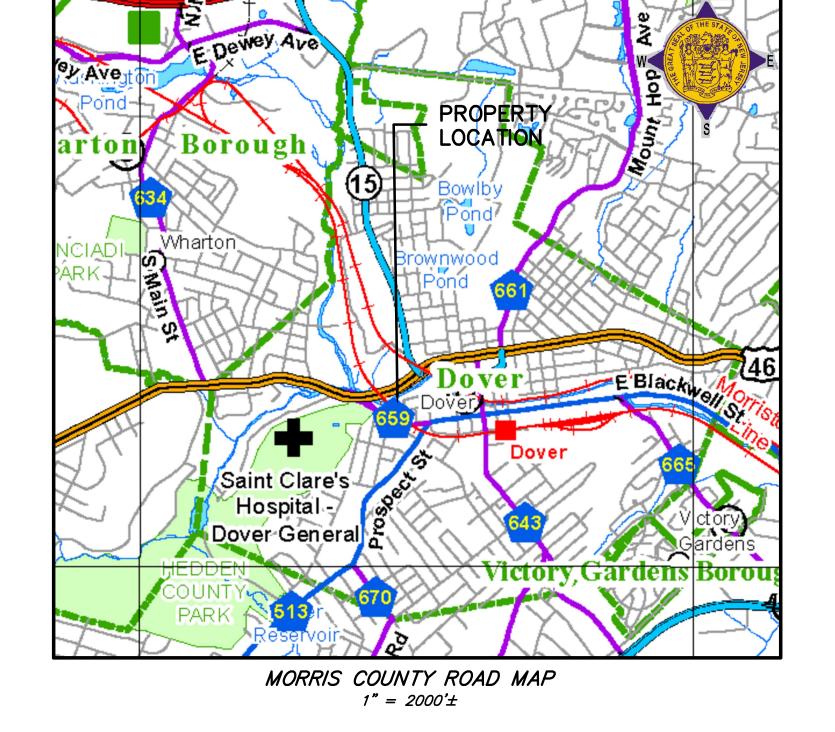

ZONING SCHEDULE				
BULK REQUIREMENT	BHRP ZONE	EXISTING	PROPOSED	
MIN. LOT AREA	NONE	78,007 S.F.	NO CHANGE	
MIN. LOT WIDTH	NONE	N/A	NO CHANGE	
MIN. FRONT YARD SETBACK	N/A	N/A	NO CHANGE	
MIN. REAR YARD SETBACK	NONE	76± FT.	NO CHANGE	
MIN. SIDE YARD SETBACK	NONE	O FT.	NO CHANGE	
MAXIMUM BUILDING HEIGHT	96 FT.	<35 FT	33.67 FT.	

\*PROPERTY OWNERS WITHIN 200' OF SUBJECT LOT:

2 U S HWY 46

4-6 DEWEY ST

U S HWY 46

ADDITIONAL PARTIES TO BE NOTIFIED

JCP&L CORPORATE HEADQUARTERS

NEW JERSEY NATURAL GAS CO.

300 MADISON AVENUE

1415 WYCKOFF ROAD

WALL, NJ 07719

VERIZON, NJ INC. NJ BELL HEADQUARTERS

540 BROAD STREET NEWARK, NJ 07102

683 ROUTE 10 EAST

MORRISTOWN, NJ 07960

63-105 BASSETT

BASSETT HWY LLC

89 W BLACKWELL ST DCC PROPERTIES MANAGEMENT LLC

\*NOTICE TO BE SERVED FROM CERTIFIED LIST OBTAINED FROM THE MUNICIPALITY

ONE RT 46 LLC

JM BUTLER HOLDINGS LLC

BLOCK 1201

1201

1204

1204

1204

1204 1204 1204

510

# **VARIANCES REQUIRED:**

**ENGINEER** 

- 1. A VARIANCE IS REQUESTED FROM SECTION 3.03.04(e.) OF THE BHRP FOR A PROPOSED ROCKAWAY RIVER BUFFER MINIMUM WIDTH OF 11.6 FEET WHERE 25'
- 2. A VARIANCE IS REQUESTED FROM SECTION 3.03.04(j) OF THE BHRP FOR A TOTAL NUMBER OF 38 PARKING STALLS WHERE 54 ARE REQUIRED.

- . THE EXISTING UNDERGROUND UTILITY INFORMATION SHOWN ON THESE PLANS IS APPROXIMATE AND IS NOT GUARANTEED AS TO ACCURACY OR COMPLETENESS. PRIOR TO ANY CONSTRUCTION, THE CONTRACTOR SHALL VERIFY ALL INFORMATION. THE CONTRACTOR SHALL CALL UNDERGROUND UTILITIES 1 (800) 272-1000 FO MARKOUT PRIOR TO EXCAVATION. TEST PITS SHALL BE EXCAVATED BY THE CONTRACTOR AT ALL CROSSINGS PRIOR TO CONSTRUCTION TO ASSERTAIN EXISTING LOCATIONS, ELEVATIONS, MATERIALS, AND SIZES. TEST PIT DATA SHALL BE GIVEN TO THE ENGINEER PRIOR
- 5. ALL CONSTRUCTION WORK SHALL BE PERFORMED IN ACCORDANCE WITH ALL APPLICABLE SAFETY CODES. APPLICABLE SAFETY CODES SHALL MEAN THE LATEST EDITION INCLUDING ANY AND ALL AMENDMENTS, REVISIONS AND ADDITIONAL THERETO OF THE FEDERAL DEPARTMENT OF LABOR, OCCUPATIONAL SAFETY AND HEALTH ADMINISTRATION'S "OCCUPATIONAL SAFETY AND HEALTH
- "CONSTRUCTION SAFETY CODE": "MAINTENANCE, CONSTRUCTION AND DEMOLITION" AND "BUILDING CODE". 7. ALL CONSTRUCTION ON THIS PROJECT SHALL BE IN ACCORDANCE WITH COUNTY & TOWNSHIP STANDARDS AND INSPECTIONS AND AS GOVERNED BY THE 2019 U.S. CUSTOMARY ENGLISH STANDARD SPECIFICATIONS FOR ROAD AND BRIDGE CONSTRUCTION, OF THE NEW JERSEY DEPARTMENT OF TRANSPORTATION, WITH AMENDMENTS THERETO.
- 15. THERE SHALL BE NO BURYING OF DEBRIS OR CONSTRUCTION MATERIAL ONSITE.
- 17. THE STANDARD OF CARE FOR ALL PROFESSIONAL ENGINEERING AND RELATED SERVICES PERFORMED OR FURNISHED BY FEI UNDER THIS AGREEMENT WILL BE THE CARE AND SKILL ORDINARILY USED BY MEMBERS OF THE SUBJECT PROFESSION PRACTICING UNDER SIMILAR CIRCUMSTANCES AT THE SAME TIME AND IN THE SAME LOCALITY. FEI MAKES NO WARRANTIES, EXPRESSED OR IMPLIED, UNDER THIS AGREEMENT OR OTHERWISE, IN CONNECTION WITH THE SERVICES PROVIDED.
- 19. FEI SHALL NOT AT ANY TIME SUPERVISE, DIRECT, OR HAVE CONTROL OVER ANY CONTRACTORS WORK, NOR SHALL FEI HAVE AUTHORITY OVER OR RESPONSIBILITY FOR THE MEANS, METHODS, TECHNIQUES, SEQUENCES, OR PROCEDURES OF CONSTRUCTION SELECTED OR USED BY ANY CONTRACTOR, FOR SAFETY PRECAUTIONS AND PROGRAMS OF INCIDENT TO A CONTRACTORS WORK PROGRESS, NOR FOR ANY FAILURE OF ANY CONTRACTOR TO COMPLY WITH LAWS AND REGULATIONS APPLICABLE TO CONTRACTORS WORK. THE CLIENT WAVES ANY CLAIMS AGAINST FERRIERO
- GIVEN BY CLIENT WITHOUT THE CONSULTATION AND ADVICE OF ENGINEER.
- 22. ALL DIMENSIONS SHOWN ON THE PLANS SHALL BE FIELD VERIFIED BY THE CONTRACTOR PRIOR TO CONSTRUCTION. CONTRACTOR SHALL NOTIFY ENGINEER IF ANY DISCREPANCIES EXIST PRIOR TO PROCEEDING WITH CONSTRUCTION FOR NECESSARY PLAN CHANGES. NO EXTRA COMPENSATION SHALL BE PAID TO THE CONTRACTOR FOR WORK HAVING TO BE REDONE DUE TO DIMENSIONS OR GRADES SHOWN INCORRECTLY ON THESE PLANS IF SUCH NOTIFICATION HAS NOT BEEN GIVEN.

  23. SOLID WASTE TO BE DISPOSED OF BY CONTRACTOR IN ACCORDANCE WITH ALL LOCAL, STATE AND FEDERAL REGULATIONS.

- ACTIVITIES PROPOSED. 29. NO WORK IS PROPOSED WITHIN THE FLOODWAY. THERE SHALL BE NO ON-SITE BURIAL OF CONSTRUCTION MATERIAL, TREES, TREE STUMPS, BRUSH OR OTHER SURPLUS MATERIAL. ALL SUCH MATERIAL SHALL BE REMOVED FROM THE SITE AND DISPOSED OF IN
- FERRIERO ENGINEERING, INC. 180 MAIN STREET, P.O. BOX 571 CHESTER, NJ 07930 (908) - 879 - 6209

BYRNE DESIGN ASSOCIATES, INC.

10 MAIN STREET, CHESTER, NJ 07930

APPLICANT/OWNER:

INGLESINO, WEBSTER,

CHRIS MURPHY

ATTORNEY:

SUITE 204

ARCHITECT:

WEST MORRIS OZF PROPERTY

DEVELOPMENT COMPANY C/O

37 NOLANS POINT PARK ROAD


LAKE HOPATCONG, NJ 07849

WYCISKALA & TAYLOR, LLC

600 PARSIPPANY ROAD,

PARSIPPANY, NJ 07054


CIVIL/SITE ENGINEER:

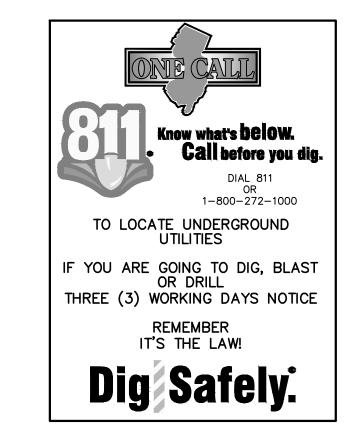

INDEX OF DRAWINGS	
DESCRIPTION	SHEET NO.
TITLE SHEET	1
DEMOLITION & EXISTING CONDITIONS PLAN	2
SITE & UTILITY PLAN	3
GRADING, SOIL EROSION & SEDIMENT CONTROL PLAN	4
LANDSCAPING PLAN	5
LIGHTING PLAN	6
SOIL EROSION & SEDIMENT CONTROL DETAILS	7
CONSTRUCTION DETAILS	8
CONSTRUCTION DETAILS	9

# PRELIMINARY AND FINAL SITE PLAN WITH VARIANCES

107-111 BASSETT HIGHWAY BLOCK 1201 LOT 6.01 TOWN OF DOVER MORRIS COUNTY **NEW JERSEY** 

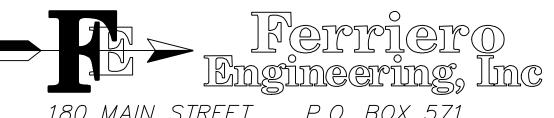

180 MAIN STREET P.O. BOX 571 CHESTER, NEW JERSEY 07930 CERTIFICATE OF AUTHORIZATION 24GA27935400


9/16/21

PAUL W. FERRIERO

N.J. PROFESSIONAL ENGINEER NO. GE32978

FEI No. 201051

SHEET 1 OF 9

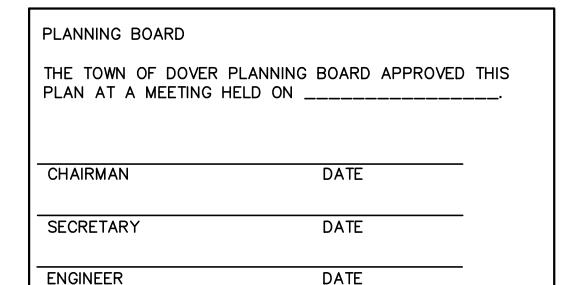

KEY MAP

 $1'' = 200' \pm$ 

TOWN OF DOVER TAX MAP REFERENCE BLOCK 1201 LOT 6.01, AS SHOWN ON TAX MAP SHEET 12.
BOUNDARY, TOPOGRAPHY AND EXISTING CONDITIONS FROM FIELD SURVEY BY THIS FIRM ON NOVEMBER 9, 2020. THE PROJECT VERTICAL DATUM IS BASED UPON NAVD 88 DERIVED USING RTK RECEIVERS AND KEYNET.

TO CONSTRUCTION TO PERMIT ADJUSTMENTS AS REQUIRED. . UTILITY LOCATIONS APPROXIMATE. CONTRACTOR IS RESPONSIBLE TO OBTAIN MARKOUT FOR THE VERIFICATION OF ALL UNDERGROUND UTILITIES PRIOR TO EXCAVATION.

STANDARDS" (OSHA); "SAFETY AND HEALTH REGULATIONS FOR CONSTRUCTION" OF THE STATE OF NEW JERSEY, DEPARTMENT OF LABOR AND INDUSTRY, BUREAU OF ENGINEERING AND SAFETY; 12. ALL SOIL TESTING FOR STRUCTURAL COMPONENTS TO BE DONE BY OTHERS. THIS INCLUDES BUT IS NOT LIMITED TO STRUCTURAL STABILITY, WATER TABLE ELEVATION, FOOTING DESIGN, PRESENCE OR ABSENCE OF BURIED OR UNSUITABLE MATERIAL AND DEPTH TO ROCK. SITE DESIGN ENGINEER ACCEPTS NO LIABILITY FOR LOST TIME OR ADDITIONAL EXPENSE DUE TO CHANGES OCCURRING FROM

13. BUILDER/OWNER/CONTRACTOR OR AUTHORIZED REPRESENTATIVE TO APPROVE PROPOSED BUILDING ELEVATIONS AND LOCATION PRIOR TO ANY EXCAVATION. IF CHANGES ARE REQUESTED, THE SITE DESIGN ENGINEER IS TO BE NOTIFIED IMMEDIATELY. THE SITE ENGINEER ACCEPTS NO LIABILITY FOR LOT TIME OR ADDITIONAL EXPENSE DUE TO ANY CHANGES OCCURRING FROM FIELD MODIFICATIONS.

14. THE OWNER, BY AUTHORIZING FERRIERO ENGINEERING, INC. TO PERFORM CONSTRUCTION STAKE OUT OF ANY COMPONENT OF THE WORK HAS ACKNOWLEDGED THEIR REVIEW AND APPROVAL OF THE

16. ALL PROPOSED STRIPING SHALL BE COMPRISED OF LONG-LIFE EPOXY BASED PAINT. CONTRACTOR SHALL PROVIDE THE CONSTRUCTION MANAGER WITH A SUBMITTAL OF THE PROPOSED MATERIALS FOR APPROVAL PRIOR TO CONSTRUCTION.

18. FERRIERO ENGINEERING, INC. MAY USE ALL INFORMATION CONTAINED IN OUTSIDE CONSULTANTS REPORTS, DATA, SURVEYS AND INSTRUCTIONS FROM THE CONSULTANTS THAT HAVE BEEN HIRED BY THE CLIENT TO WORK ON THIS PROJECT IN PERFORMING ITS SERVICES AND IS ENTITLED TO RELY UPON THE ACCURACY AND COMPLETENESS THEREOF. FEI SHALL NOT BE HELD RESPONSIBLE FOR ANY ERRORS OR OMISSIONS THAT MAY ARISE AS A RESULT OF ERRONEOUS OR INCOMPLETE INFORMATION PROVIDED BY THE CLIENT AND/OR THE CLIENT'S CONSULTANTS AND/OR CONTRACTORS.

ENGINEERING, INC. ARISING FROM ERRORS, OMISSIONS, OR INACCURACIES IN DOCUMENTS OR OTHER INFORMATION PROVIDED TO US BY OTHERS.

20. FEI SHALL NOT BE RESPONSIBLE FOR THE ACTS OR OMISSIONS OF ANY CONTRACTOR, SUBCONTRACTOR, SUPPLIER, OR OF ANY CONTRACTORS AGENTS OR EMPLOYEES OR ANY OTHER PERSONS AT THE PROJECT SITE OR OTHERWISE FURNISHING OR PERFORMING ANY CONSTRUCTION WORK; OR FOR ANY DECISION MADE ON INTERPRETATIONS OR CLARIFICATIONS OF THE CONSTRUCTION CONTRACT

21. ALL DESIGN DOCUMENTS PREPARED OR FURNISHED BY FEI ARE INSTRUMENTS OF SERVICE, AND FEI RETAINS AN OWNERSHIP AND PROPERTY INTEREST (INCLUDING COPYRIGHT AND THE RIGHT TO REUSE) IN SUCH DOCUMENTS, WHETHER OR NOT THE PROJECT IS COMPLETED. THE CLIENT MAY OBTAIN COPIES FOR INFORMATION AND REFERENCE IN CONNECTION WITH THE PROJECT PROVIDED THAT FEES FOR SERVICES RENDERED HAVE BEEN PAID IN FULL. IN ADDITION, THE REASONABLE COSTS OF RESEARCH AND REPRODUCTION FOR COPIES OR RECORDS SHALL BE PAID.


24. ALL EXCAVATED UNSUITABLE MATERIAL MUST BE TRANSPORTED TO AN APPROVED DISPOSAL LOCATION. 25. THIS PROJECT PROPOSES LESS THAN 1-ACRE OF DISTURBANCE AND A REDUCTION IN IMPERVIOUS COVERAGE SO IT IS NOT CONSIDERED A "MAJOR DEVELOPMENT" AS DEFINED BY THE NJDEP. . THIS PROPERTY IS LOCATED WITHIN THE BASSET HIGHWAY REDEVELOPMENT PLAN AREA.


33. IF THIS DOCUMENT DOES NOT CONTAIN A RAISED SEAL OF THE UNDERSIGNED PROFESSIONAL, IT IS NOT AN AUTHORIZED ORIGINAL DOCUMENT.


27. THERE ARE NO FRESHWATER WETLANDS WITHIN 150' OF THE SUBJECT PROPERTY BASED ON NJDEP GEOWEB DATABASE MAPPING 28. A PORTION OF THIS PROJECT IS LOCATED WITHIN A FLOOD HAZARD AREA AND RIPARIAN ZONE AND QUALIFIES FOR PERMITS BY RULE #4, #7, #8 AND #10 FROM N.J.A.C. 7:13 FOR THE VARIOUS

ACCORDANCE WITH ALL AFFICABLE LAWS AND REGULATIONS.

31. THESE PLANS HAVE BEEN PREPARED FOR THE PURPOSES OF MUNICIPAL AND AGENCY REVIEW AND APPROVAL. THESE PLANS ARE NOT TO BE UTILIZED AS CONSTRUCTION DOCUMENTS UNTIL ALL CONDITIONS OF APPROVAL HAVE BEEN SATISFIED AND ALL REQUIRED AGENCY PERMITS HAVE BEEN OBTAINED BY THE OWNER. 32. ANY DISCREPANCIES BETWEEN THE SITE INFORMATION PROVIDED ON THE PLAN, AND THOSE FOUND AT THE SITE SHALL BE REPORTED TO THE DESIGN ENGINEER AT ONCE.

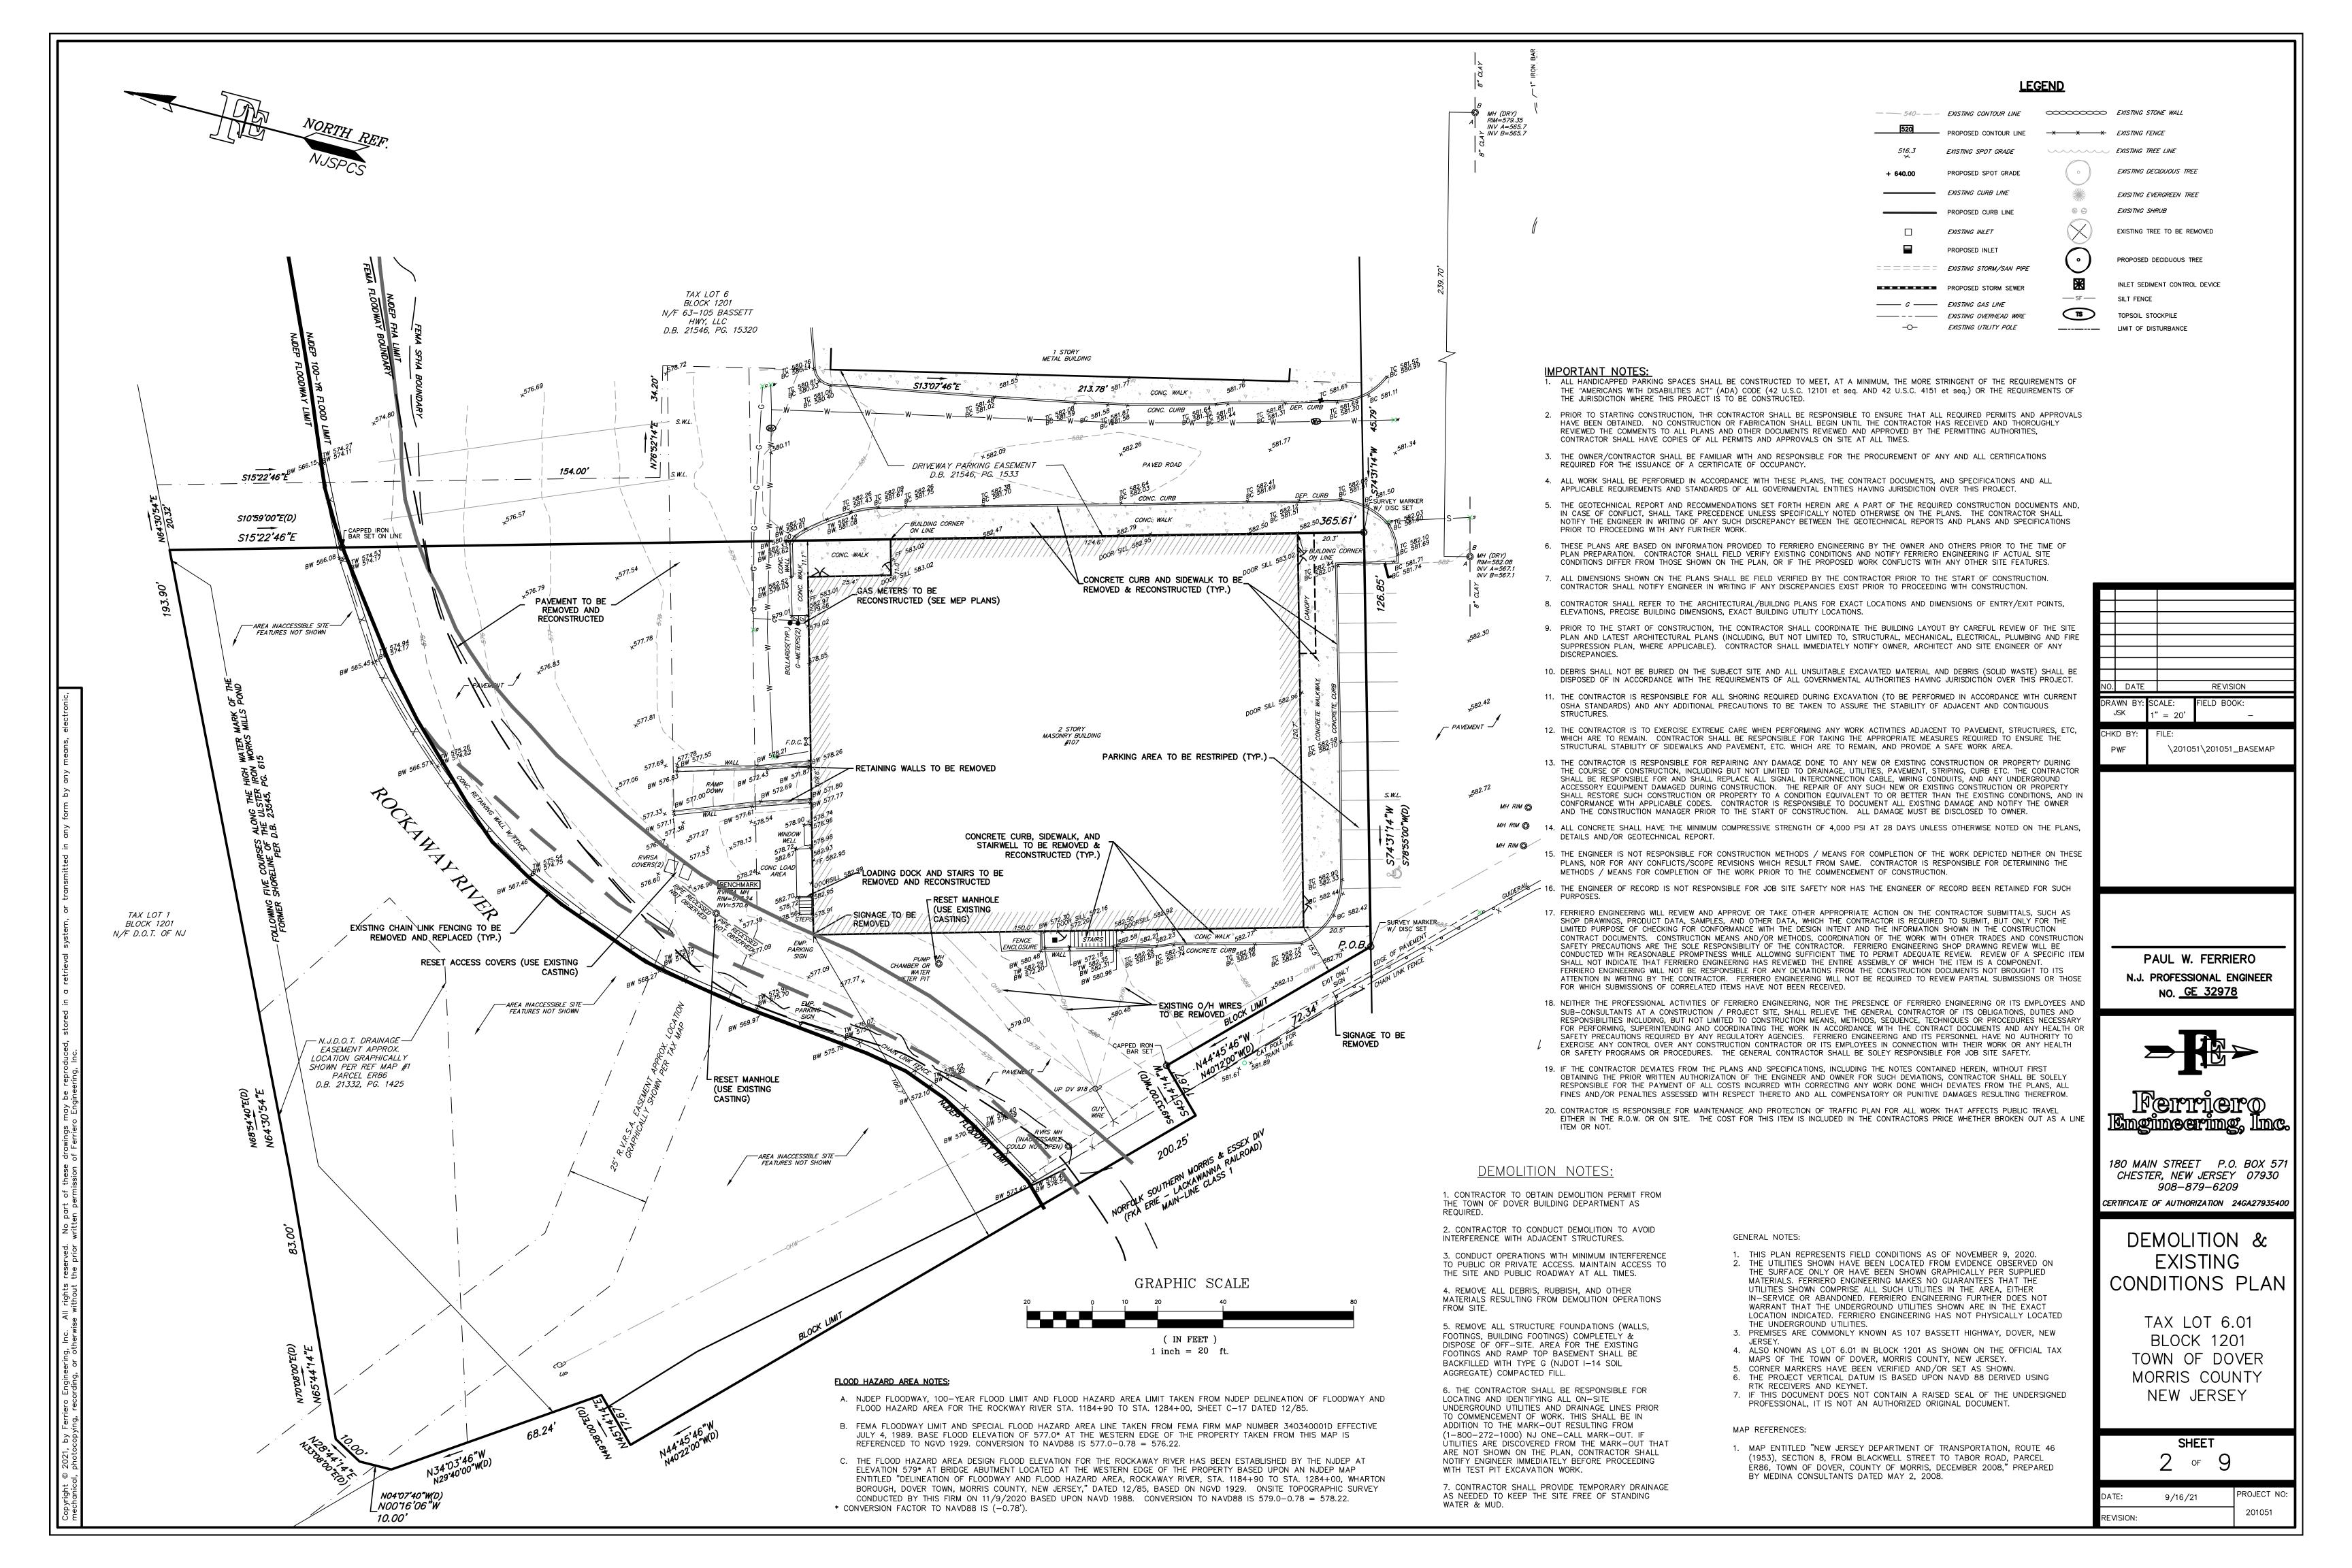

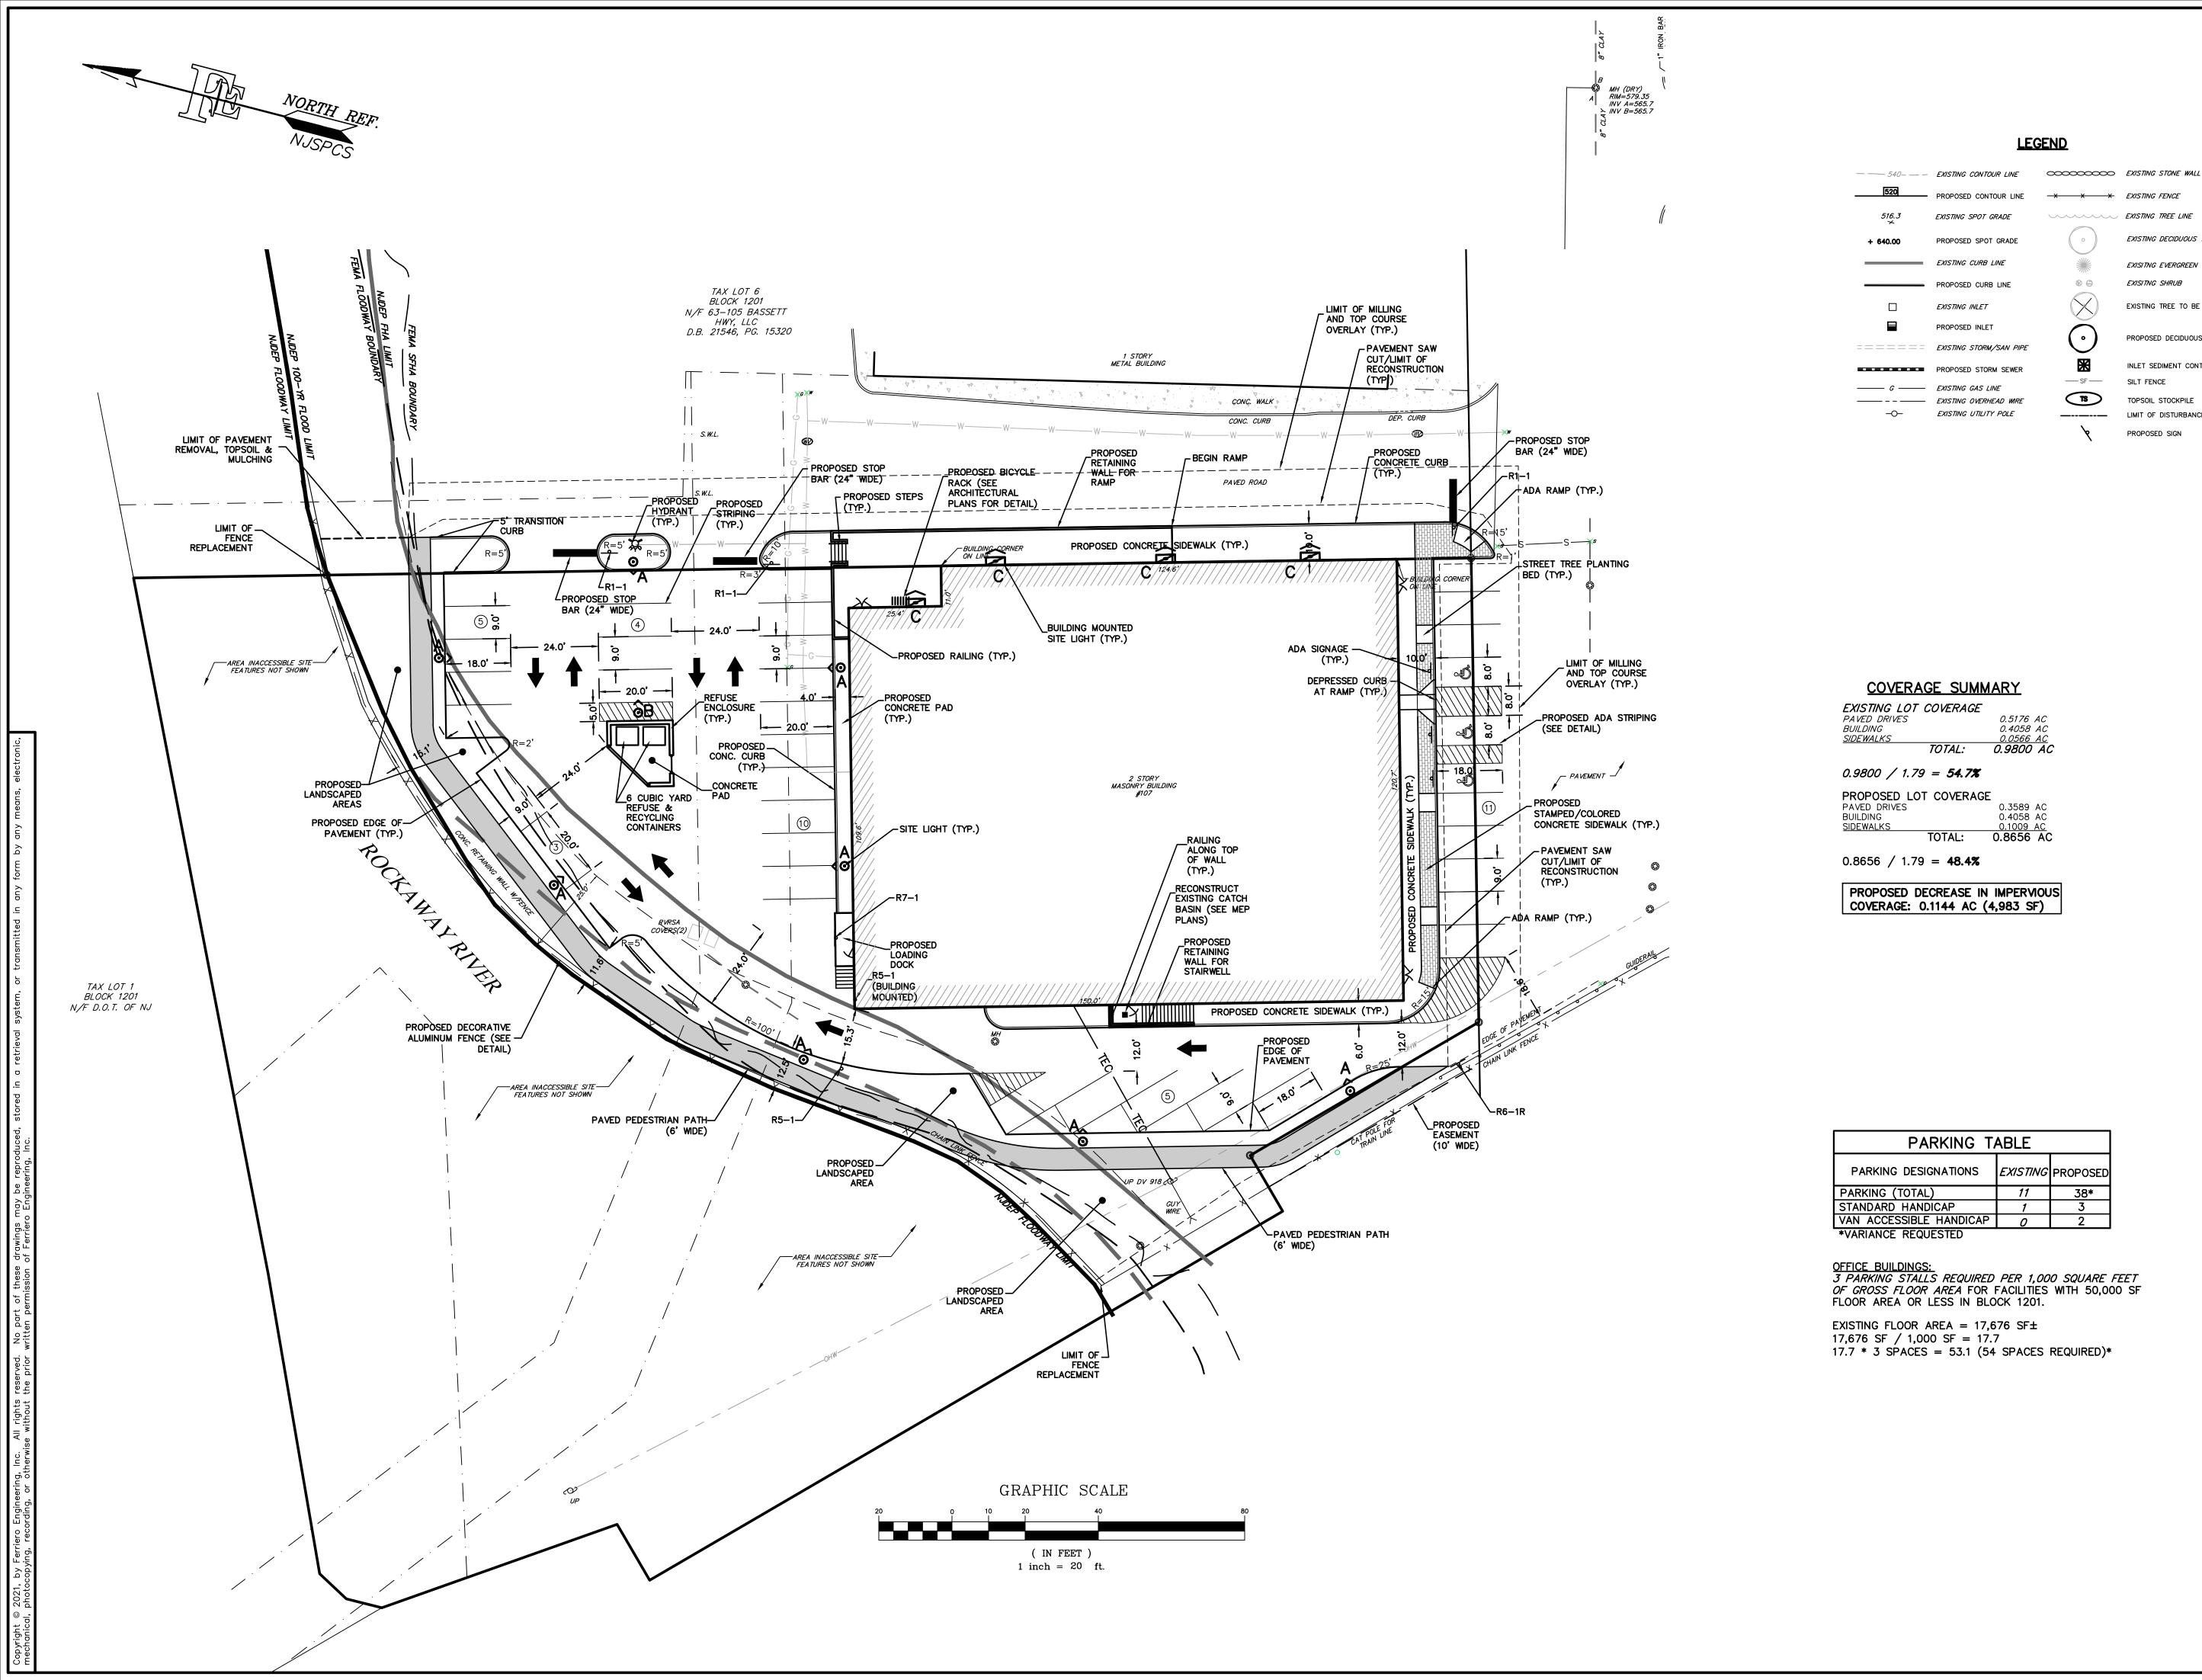

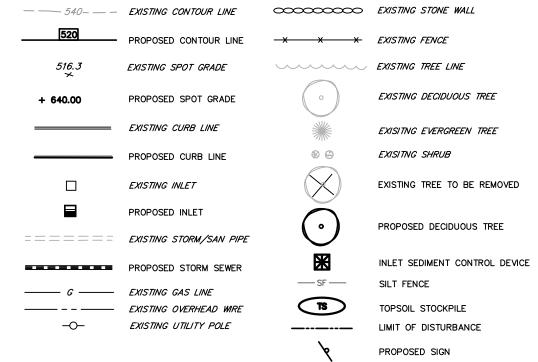

			·		
NO.	DATE		REVISION		
DRA	WN BY:	SC	CALE:	FIELD BOOK:	
·	JSK	1"	' = 20'	_	
СНК	D BY:		FILE:		
Р	WF		\201051\201051_BASEMAP		

PAUL W. FERRIERO N.J. PROFESSIONAL ENGINEER NO. <u>GE 32978</u>



Merriero Engineering, Inc.

180 MAIN STREET P.O. BOX 571 CHESTER, NEW JERSEY 07930 908-879-6209


CERTIFICATE OF AUTHORIZATION 24GA27935400


SITE & UTILITY PLAN


TAX LOT 6.01 BLOCK 1201 TOWN OF DOVER MORRIS COUNTY NEW JERSEY

SHEET 3 of 9

PROJECT NO: 9/16/21 201051 REVISION:

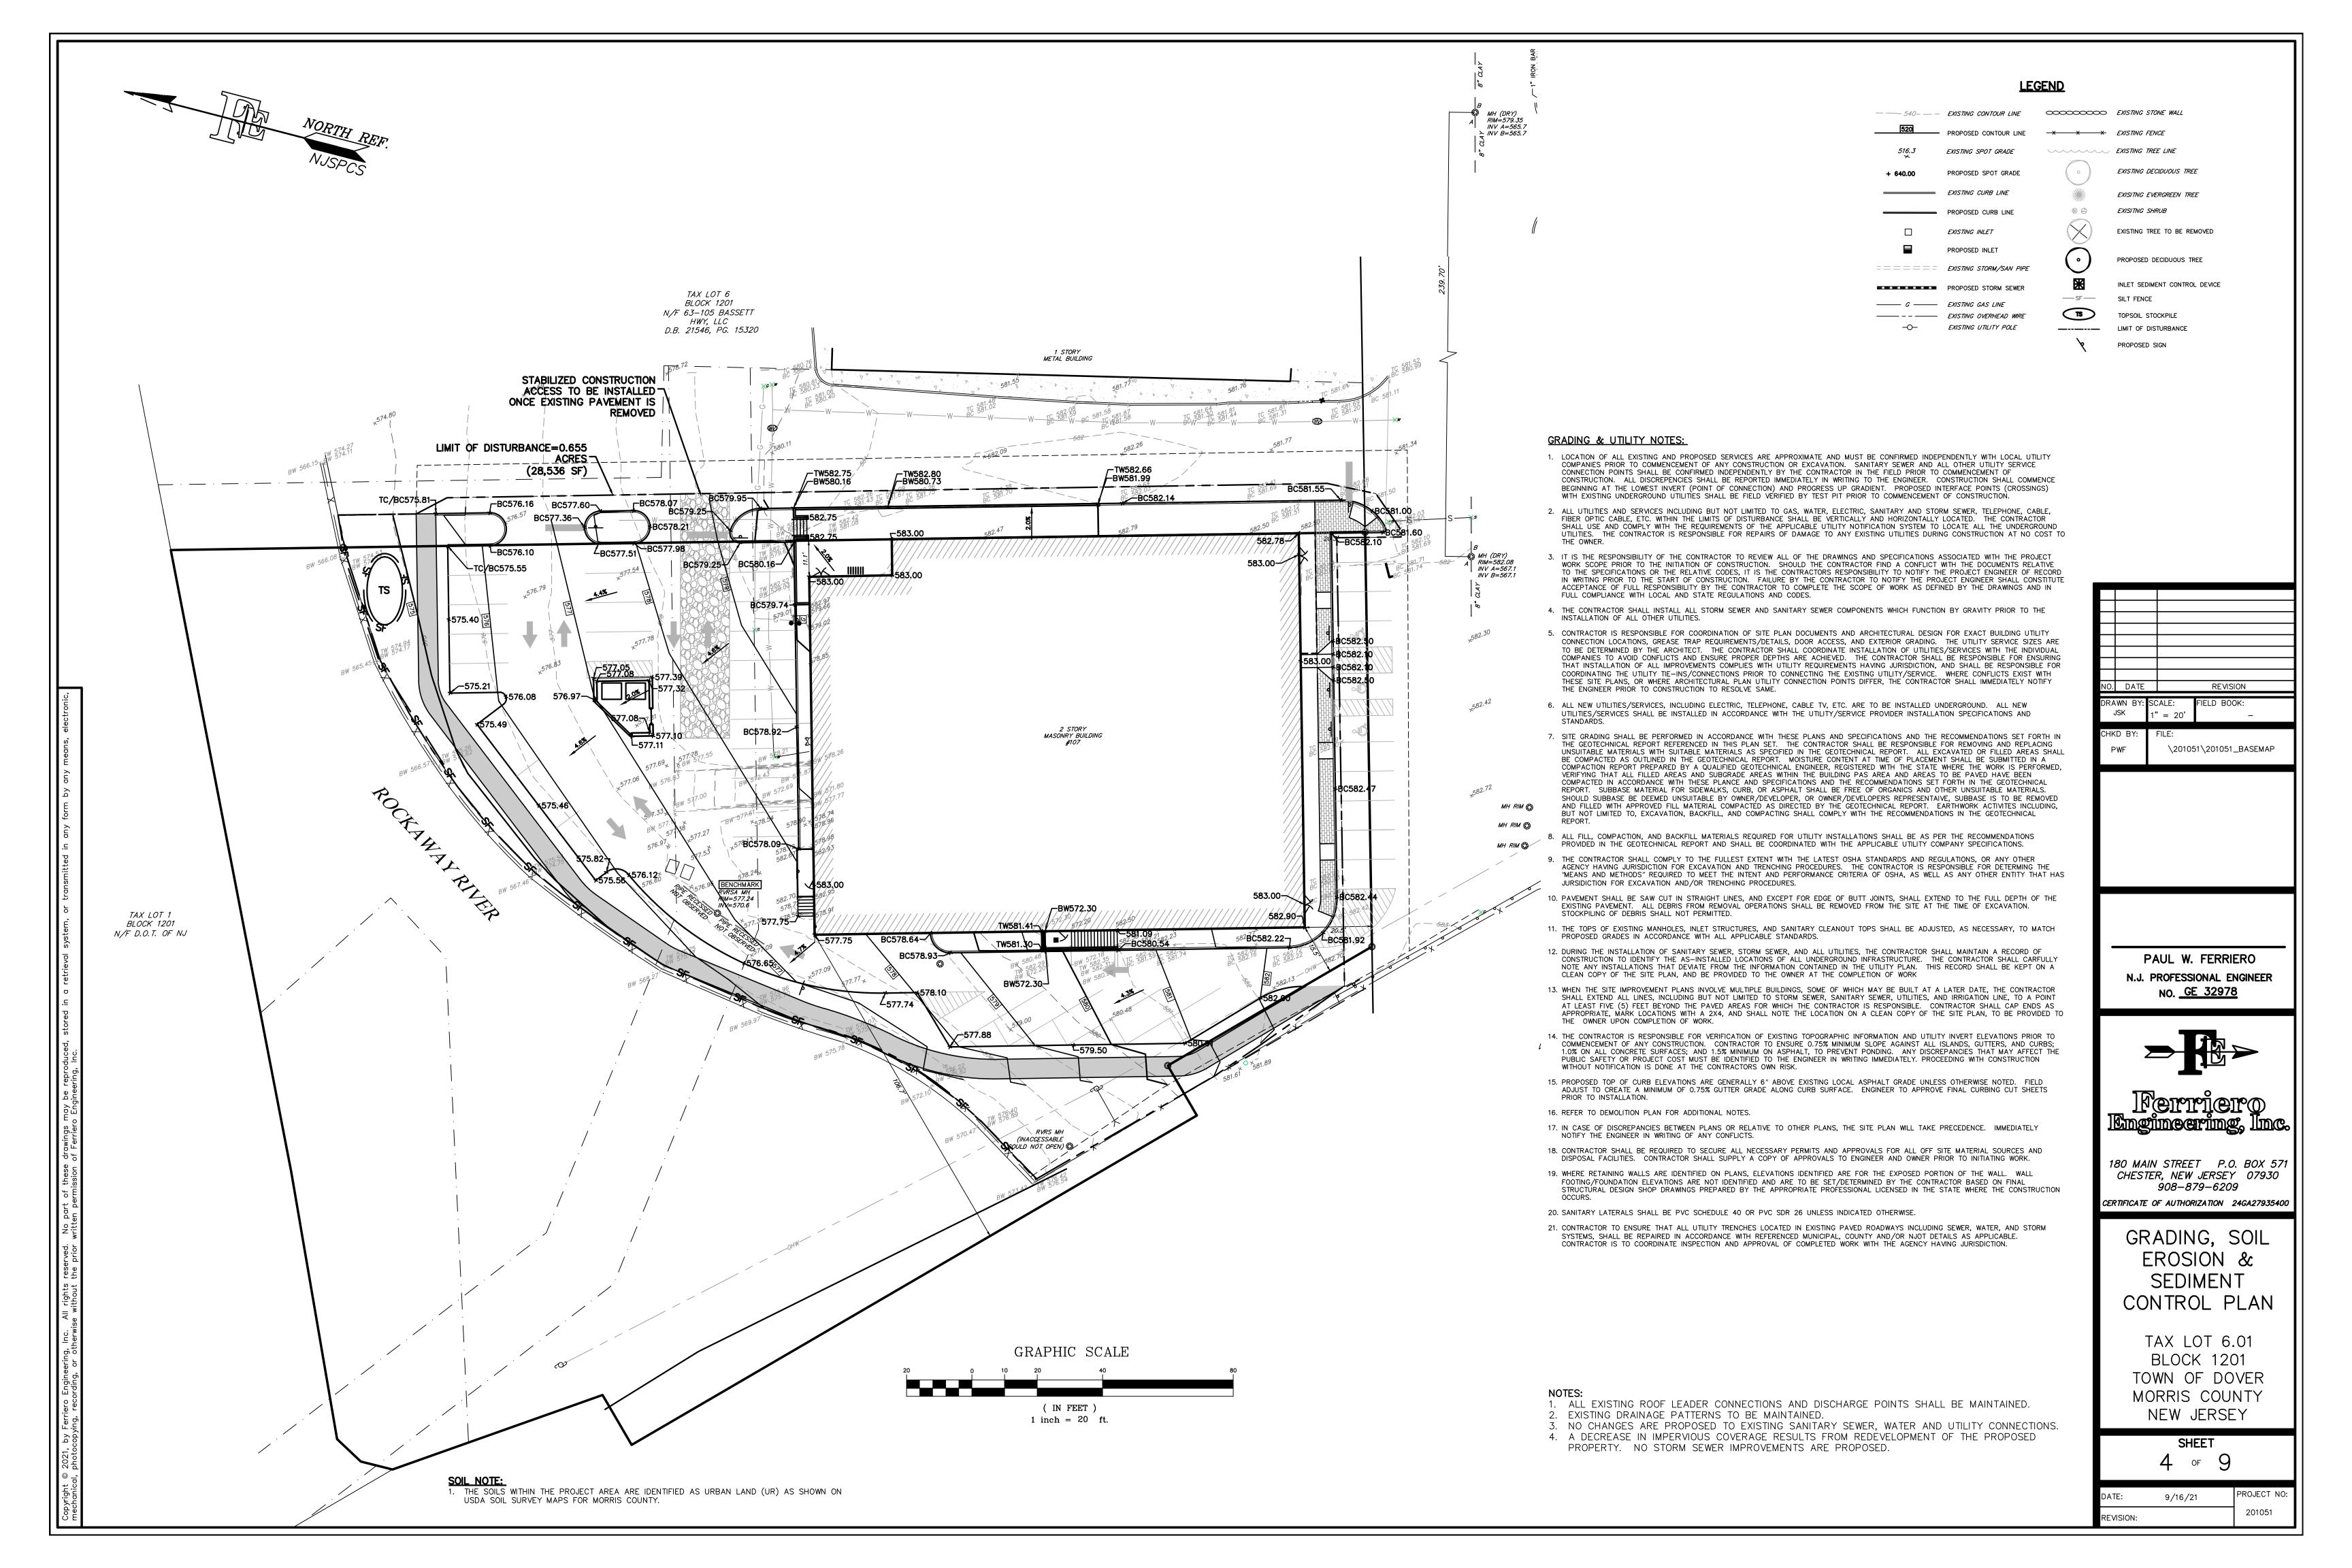

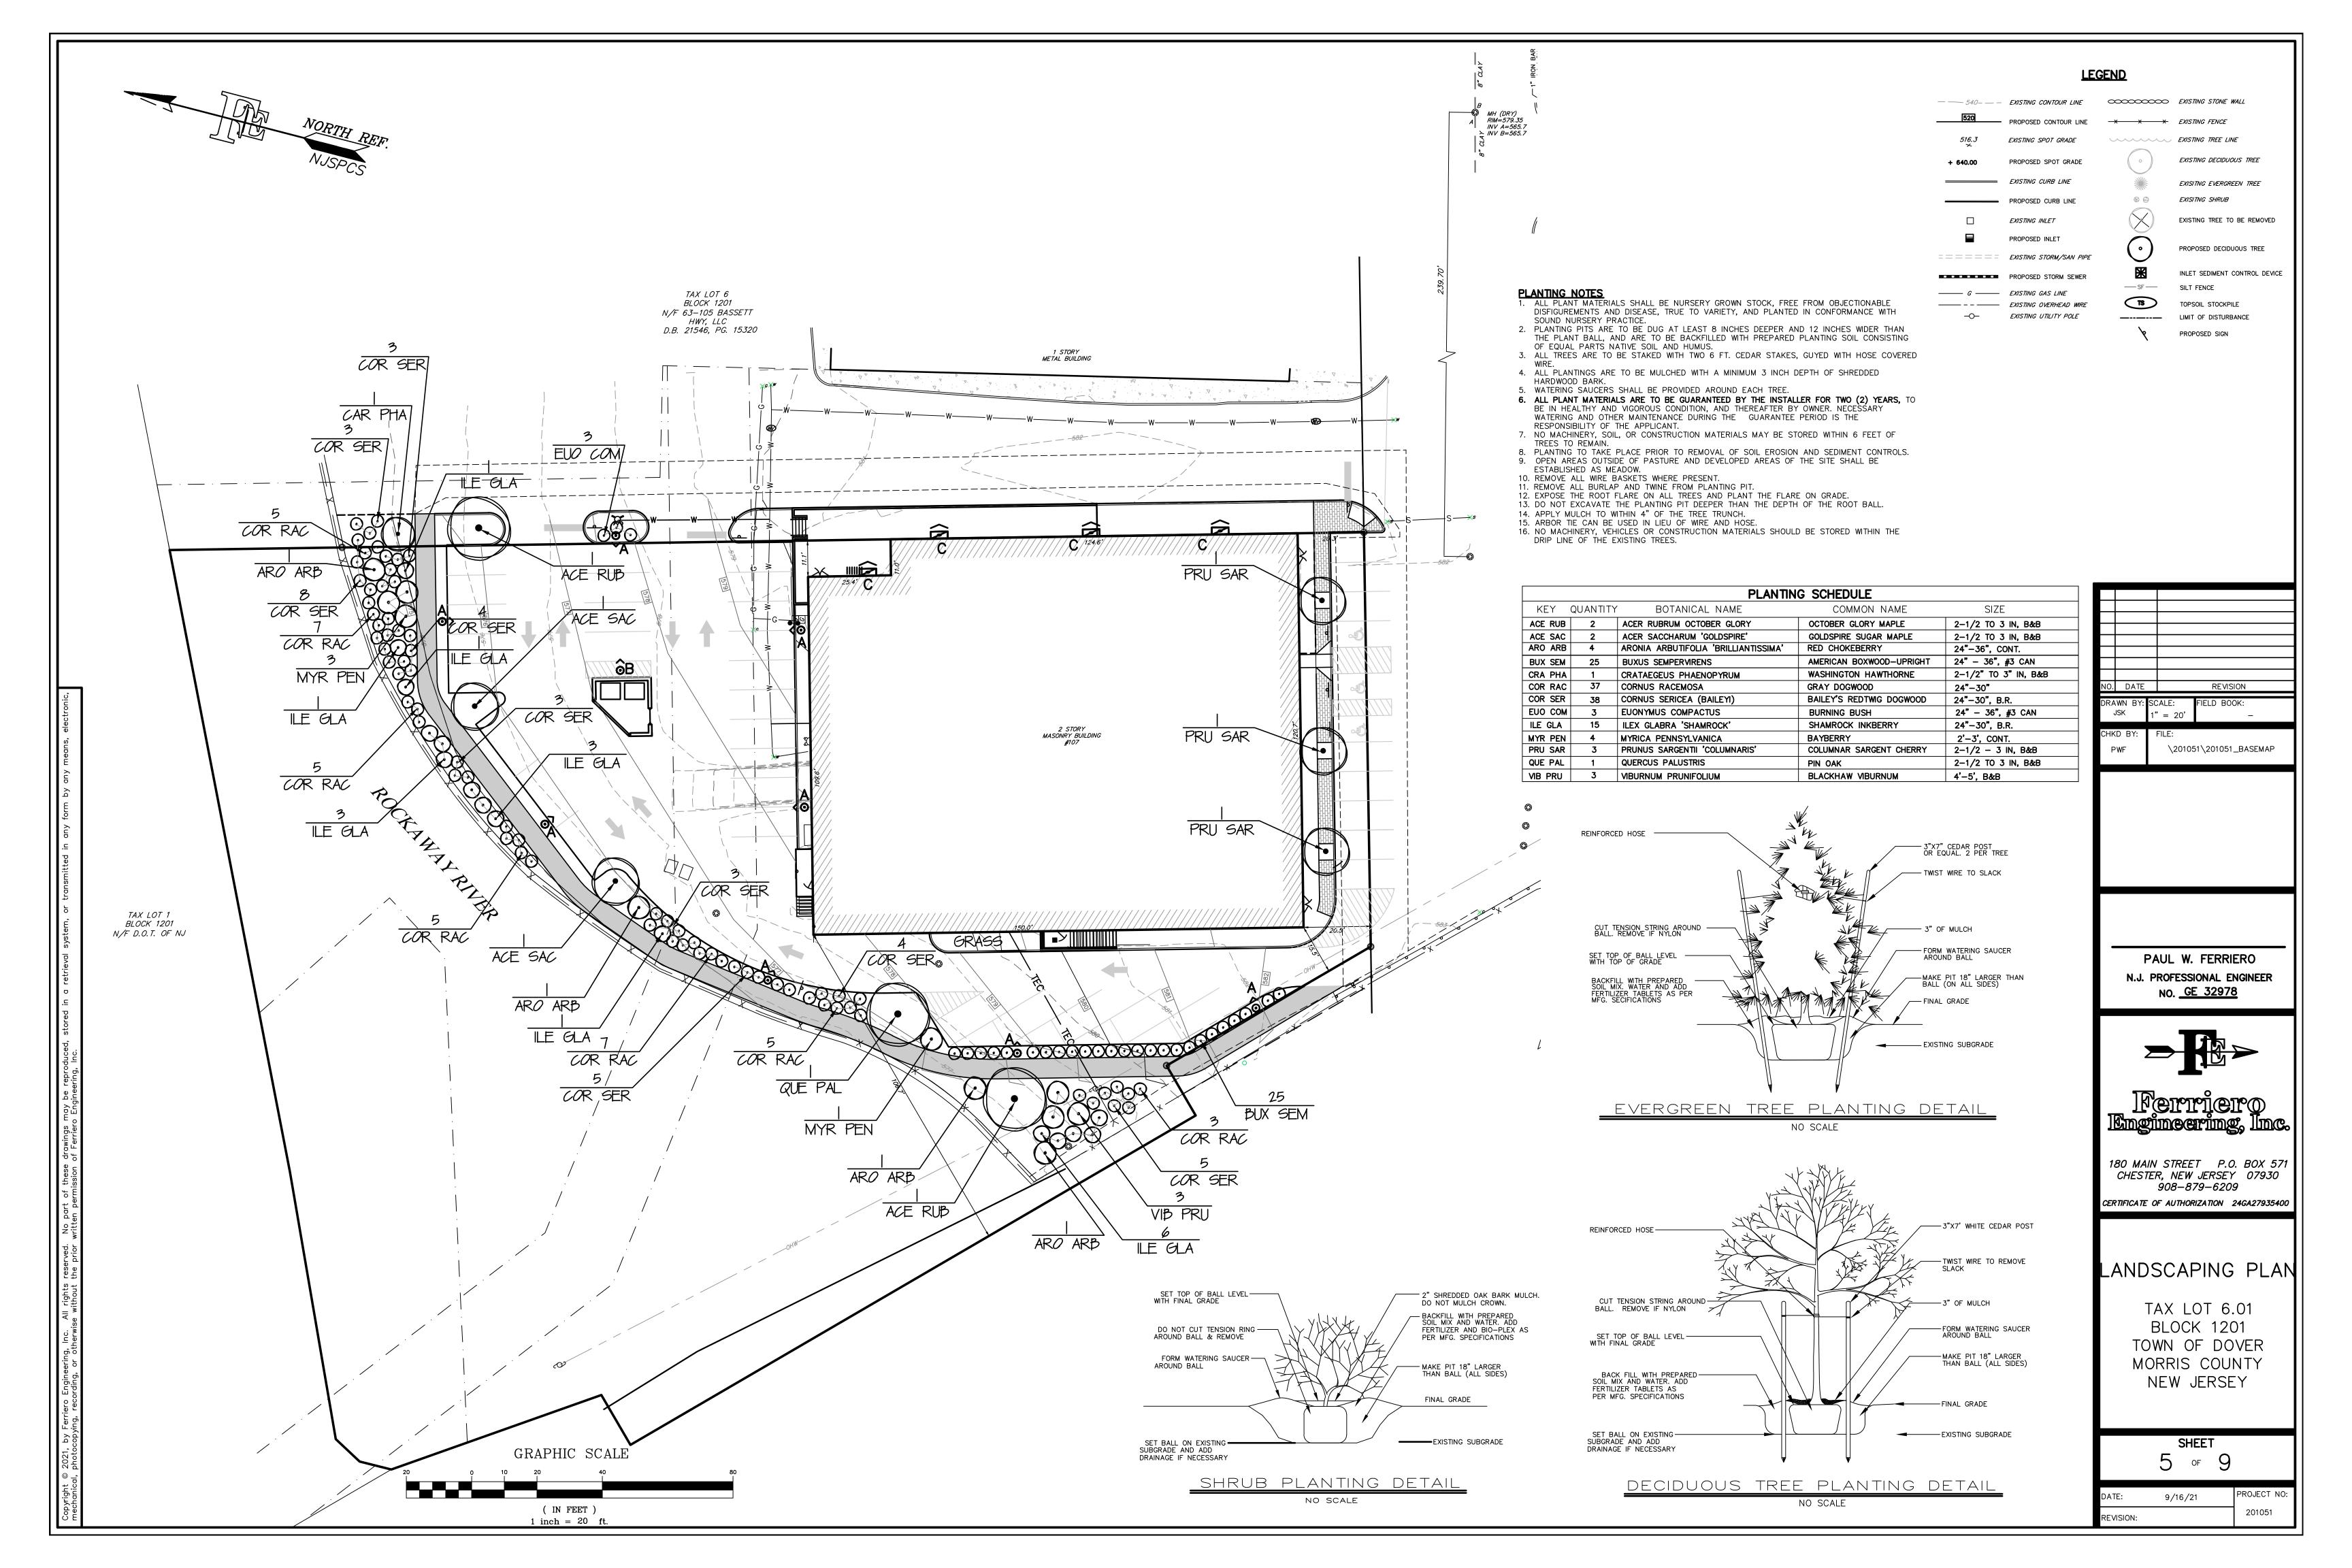

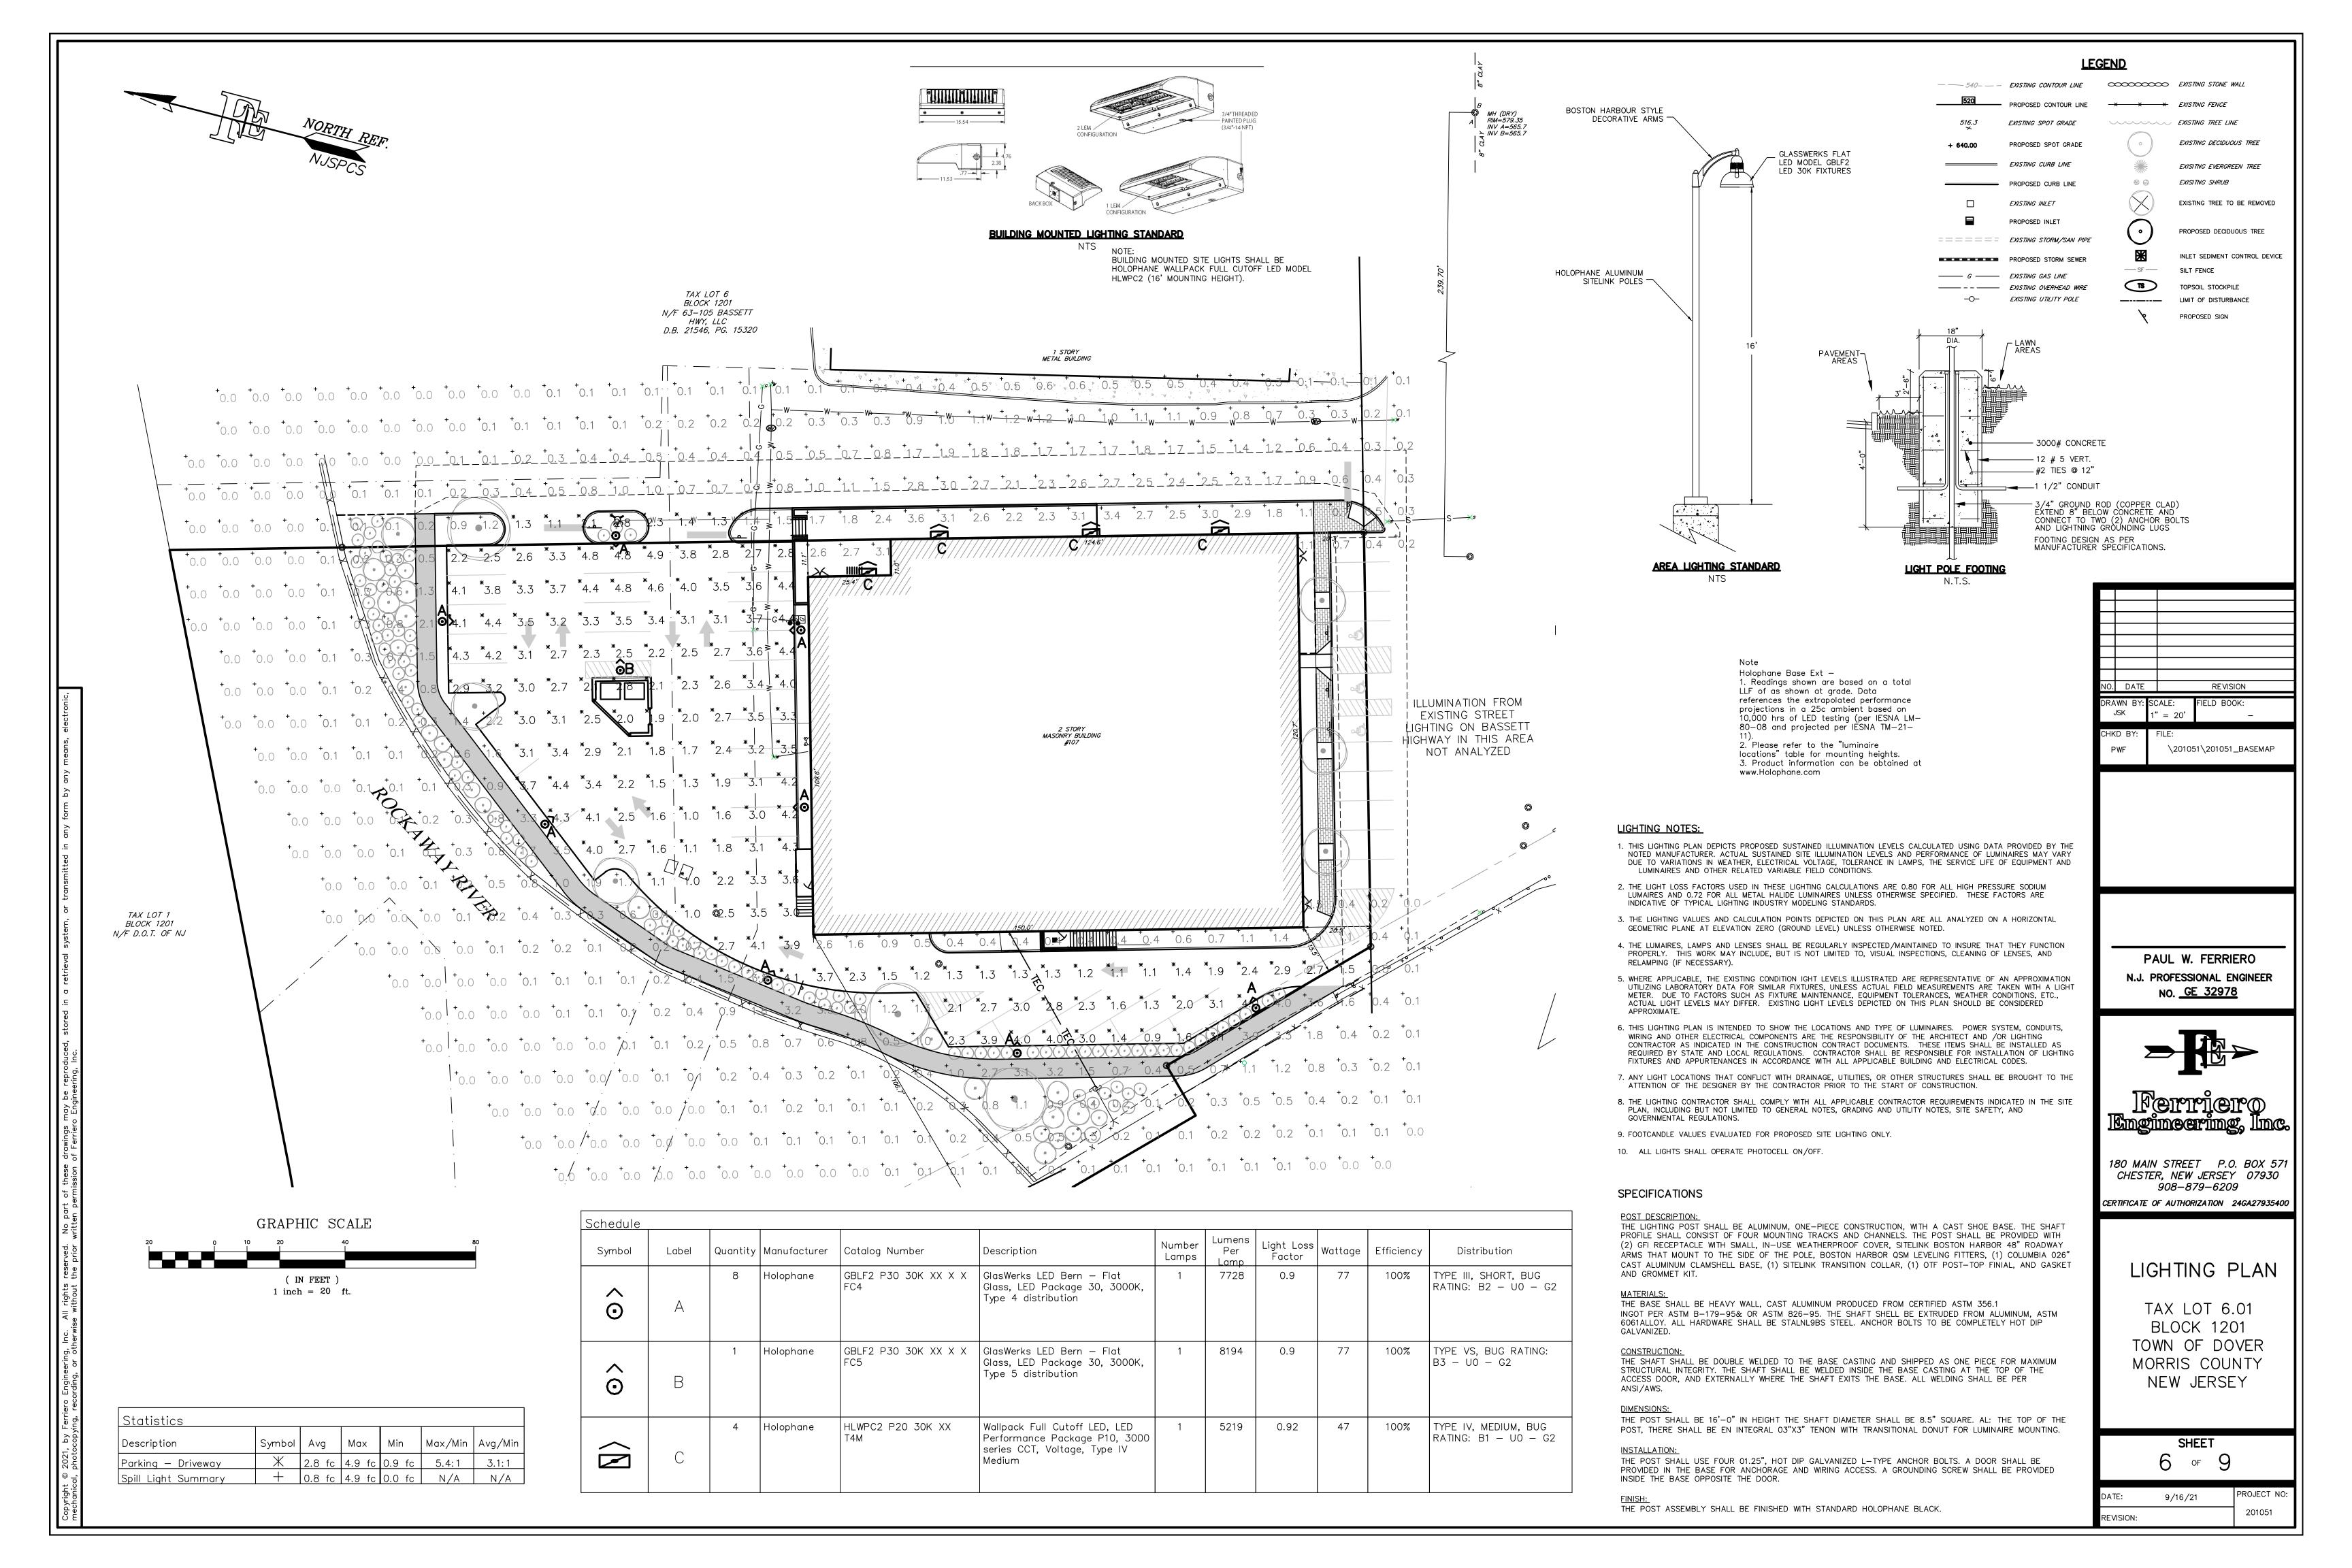

### MORRIS COUNTY SOIL CONSERVATION DISTRICT SOIL EROSION AND SEDIMENT CONTROL NOTES

- ALL SOIL EROSION AND SEDIMENT CONTROL PRACTICES WILL BE INSTALLED IN ACCORDANCE WITH THE STANDARDS FOR SOIL EROSION AND SEDIMENT CONTROL IN NEW JERSEY, AND WILL BE PLACE PRIOR TO ANY MAJOR SOIL DISTURBANCE, OR IN THEIR PROPER SEQUENCE AND MAINTAINED UNTIL PERMANENT PROTECTION IS ESTABLISHED.
- ANY DISTURBED AREA THAT WILL BE LEFT EXPOSED FOR MORE THAN THIRTY DAYS AND NOT SUBJECT TO CONSTRUCTION TRAFFIC SHALL IMMEDIATELY RECEIVE A TEMPORARY SEEDING. IF THE SEASON PROHIBITS TEMPORARY SEEDING, THE DISTURBED AREA WILL BE MULCHED WITH STRAW OR HAY AND TACKED IN ACCORDANCE WITH THE NEW JERSEY STANDARDS. SEE NOTE 21 BELOW.
- PERMANENT VEGETATION IS TO BE ESTABLISHED ON EXPOSED AREAS WITHIN TEN (10) DAYS AFTER FINAL GRADING. MULCH IS TO BE USED FOR PROTECTION UNTIL VEGETATION IS ESTABLISHED. SEE NOTE 22 BELOW.
- IMMEDIATELY FOLLOWING INITIAL DISTURBANCE OR ROUGH GRADING. ALL CRITICAL AREAS (STEEP SLOPES, SANDY SOILS, WET CONDITIONS) SUBJECT TO EROSION WILL RECEIVE A TEMPORARY SEEDING IN ACCORDANCE WITH NOTE 21 BELOW.
- TEMPORARY DIVERSION BERMS ARE TO BE INSTALLED ON ALL CLEARED ROADWAYS AND EASEMENT AREAS. SEE THE DIVERSION DETAIL.
- PERMANENT SEEDING AND STABILIZATION TO BE IN ACCORDANCE WITH THE "STANDARDS FOR PERMANENT VEGETATIVE COVER FOR SOIL STABILIZATION COVER". SPECIFIED RATES AND LOCATIONS SHALL BE ON THE APPROVED SOIL EROSION AND SEDIMENT CONTROL PLAN.
- 7. THE SITE SHALL AT ALL TIMES BE GRADED AND MAINTAINED SO THAT ALL STORM WATER RUNOFF IS DIVERTED TO SOIL EROSION AND SEDIMENT CONTROL FACILITIES.
- 8. ALL SEDIMENTATION STRUCTURES (SILT FENCE, INLET FILTERS, AND SEDIMENT BASINS) WILL BE INSPECTED AND MAINTAINED DAILY.
- STOCKPILES SHALL NOT BE LOCATED WITHIN 50' OF A FLOODPLAIN, SLOPE, DRAINAGE FACILITY, OR ROADWAY. ALL STOCKPILE BASES SHALL HAVE A SILT FENCE PROPERLY ENTRENCHED AT THE TOE
- 10. A STABILIZED CONSTRUCTION ACCESS WILL BE INSTALLED, WHENEVER AN EARTHEN ROAD INTERSECTS WITH A PAVED ROAD. SEE THE STABILIZED CONSTRUCTION ACCESS DETAIL AND CHART FOR DIMENSIONS.
- ALL NEW ROADWAYS WILL BE TREATED WITH SUITABLE SUBBASE UPON ESTABLISHMENT OF FINAL GRADE ELEVATIONS.
- 12. PAVED ROADWAYS MUST BE KEPT CLEAN AT ALL TIMES.

OR APPROVED MATERIAL. SEE THE DEWATERING DETAIL.

- 13. BEFORE DISCHARGE POINTS BECOME OPERATIONAL, ALL STORM DRAINAGE OUTLETS WILL BE STABILIZED AS REQUIRED.
- 14. ALL DEWATERING OPERATIONS MUST DISCHARGED DIRECTLY INTO A SEDIMENT FILTER AREA. THE SEDIMENT FILTER SHOULD BE COMPOSED OF A FABRIC
- ALL SEDIMENT BASINS WILL BE CLEANED WHEN THE CAPACITY HAS BEEN REDUCED BY 50%. A CLEAN-OUT ELEVATION WILL BE IDENTIFIED ON THE PLAN AND A MARKER INSTALLED ON THE SITE.
- DURING AND AFTER CONSTRUCTION, THE APPLICANT WILL BE RESPONSIBLE FOR THE MAINTENANCE AND UPKEEP OF THE DRAINAGE STRUCTURES, VEGETATIVE COVER, AND ANY OTHER MEASURES DEEMED APPROPRIATE BY THE DISTRICT. SAID RESPONSIBILITY WILL END WHEN COMPLETED WORK IS APPROVED BY THE MORRIS COUNTY SOIL CONSERVATION DISTRICT.
- 17. ALL TREES OUTSIDE THE DISTURBANCE LIMIT INDICATED ON THE SUBJECT PLAN OR THOSE TREES WITHIN THE DISTURBANCE AREA WHICH ARE DESIGNATED TO REMAIN AFTER CONSTRUCTION ARE TO BE PROTECTED WITH TREE PROTECTION DEVICES. SEE THE TREE PROTECTION DETAIL.
- THE MORRIS COUNTY SOIL CONSERVATION DISTRICT MAY REQUEST ADDITIONAL MEASURES TO MINIMIZE ON SITE OR OFF SITE EROSION PROBLEMS DURING CONSTRUCTION.
- THE M.C.S.C.D. MUST BE NOTIFIED, IN WRITING, AT LEAST 72 HOURS PRIOR TO ANY LAND DISTURBANCE AND A PRE-CONSTRUCTION MEETING HELD.
- CONTRACTOR TO SET UP A MEETING WITH THE INSPECTOR FOR PERIODIC OF THE TEMPORARY SEDIMENT BASIN PRIOR TO AND DURING ITS CONSTRUCTION.

# TOPSOIL STOCKPILE PROTECTION

- a. APPLY GROUND LIMESTONE AT A RATE OF 90 LBS. PER 1000 SF. b. APPLY FERTILIZER (10-20-10) AT A RATE OF 11 LBS/1000 S.F.
- APPLY PERENNIAL RYEGRASS SEED AT A RATE OF 1 LB/1000 S.F. AND ANNUAL RYEGRASS AT 1 LB. PER 1000 S.F.
- d. MULCH STOCKPILE WITH STRAW OR HAY AT AT RATE OF 90 LBS. /1000 S.F. e. APPLY A LIQUID MULCH BINDER OR TACK TO STRAW OR HAY MULCH. f. PROPERLY ENTRENCH A SILT FENCE AT THE BOTTOM OF THE STOCKPILE.

# TEMPORARY STABILIZATION SPECIFICATIONS

- a. APPLY GROUND LIMESTONE AT A RATE OF 90 LBS. PER 1000 SF.
- b. APPLY FERTILIZER (10-20-10) AT A RATE OF 11 LBS/1000 S.F. APPLY PERENNIAL RYEGRASS SEED AT A RATE OF 1 LB/1000 S.F. AND
- ANNUAL RYEGRASS AT 1 LB. PER 1000 S.F. d. MULCH STOCKPILE WITH STRAW OR HAY AT AT RATE OF 90 LBS./1000 S.F. e. APPLY A LIQUID MULCH BINDER OR TACK TO STRAW OR HAY MULCH.

# PERMANENT STABILIZATION SPECIFICATIONS

- APPLY TOPSOIL TO A DEPTH OF 5 INCHES (UNSETTLED). APPLY GROUND LIMESTONE AT A RATE OF 90 LBS. PER 1000 SF.
- AND WORK FOUR INCHES INTO SOIL. APPLY FERTILIZER (10-20-10) AT A RATE OF 11 LBS/1000 S.F.
- APPLY HARD FESCUE SEED AT 2.7 LBS./1000 S.F. AND CREEPING RED FESCUE SEED AT 0.7 LBS./1000 S.F. AND PERENNIAL RYEGRASS SEED AT 0.25 LBS./1000 S.F.
- e. MULCH STOCKPILE WITH STRAW OR HAY AT AT RATE OF 90 LBS./1000 S.F. f. APPLY A LIQUID MULCH BINDER OR TACK TO STRAW OR HAY MULCH.

### NOTE: 72 HOURS PRIOR TO ANY SOIL DISTURBANCE, NOTICE IN WRITTING, SHALL BE GIVEN TO THE TOWNSHIP ENGINEER & MORRIS COUNTY SOIL CONSERVATION DISTRICT AND A PRE-CONSTRUCTION MEETING HELD.

# DUST CONTROL

THE FOLLOWING METHODS SHOULD BE CONSIDERED FOR CONTROLLING DUST:

MULCHES: SEE STANDARDS FOR STABILIZATION WITH MULCHES ONLY (Pg. 5-1). **VEGETABLE COVER:** SEE STANDARDS FOR:

TEMPORARY VEGETATIVE COVER-Pg.7-1 PERMANENT VEGETATIVE COVER-Pq.4-1 PERMANENT STABILIZATION WITH SOD-Pg.6-1

SPRAY-ON ADHESIVES: ON MINERAL SOILS (NOT EFFECTIVE ON MUCK SOILS). KEEP

INAFFIC	OFF AREAS.		
	WATER DILUTION	TYPE OF NOZZLE	APPLY GAL./ACRE
ANIONIC ASPHALT EMULSION	7:1	COARSE SPRAY	1,200
LATEX EMULSION	12.5:1	FINE SPRAY	235
RESIN IN WATER	4:1	FINE SPRAY	300
POLACRYLAMIDE (PAM) — SPRAY ON POLACRYLAMIDE (PAM) — DRY SPREAD	APPLY ACCORDING TO MANUFACTURE'S INSTRUCTIONS. MAY ALSO BE USED AS AN ADDITIVE TO SEDIMENT BASINS TO FLOCCULATE AND PRECIPITATE SUSPENDED COLLOIDS. SEE SEDIMENT STANDARD, P. 26-		
		ı	I

TILLAGE: TO ROUGHEN SURFACE AND BRING CLODS TO THE SURFACE. THIS IS A TEMPORARY EMERGENCY MEASURE WHICH SHOULD BE USED BEFORE SOIL BLOWING STARTS. BEGIN PLOWING ON WINDWARD SIDE OF SITE. CHISEL-TYPE PLOWS SPACED ABOUT 12 INCHES APART, AND SPRING TOOTHED HARROWS ARE EXAMPLES OF EQUIPMENT WHICH MAY PRODUCE THE DESIRED EFFECT.


ACIDULATED SOY BEAN SOAP STICK NONE COARSE SPRAY 1200

SPRINKLING: SITE IS SPRINKLED UNTIL THE SURFACE IS WET.


STONE: COVER SURFACE WITH CRUSHED STONE OR COARSE GRAVEL.

BARRIERS: SOLID BOARD FENCES, SNOW FENCES, BURLAP FENCES, CRATE WALLS, BALES OF HAY, AND SIMILAR MATERIAL CAN BE USED TO CONTROL AIR CURRENTS AND SILT BLOWING.

CALCIUM CHLORIDE: SHALL BE IN THE FORM OF LOOSE, DRY GRANULES OR FLAKES FINE ENOUGH TO FEED THROUGH COMMONLY USED SPREADERS AT A RATE THAT WILL KEEP SURFACE MOIST BUT NOT CAUSE POLLUTION OR PLANT DAMAGE. IF USED ON STEEP SLOPES, THEN USE OTHER PRACTICES TO PREVENT WASHING INTO STREAMS OR ACCUMULATION AROUND PLANTS.

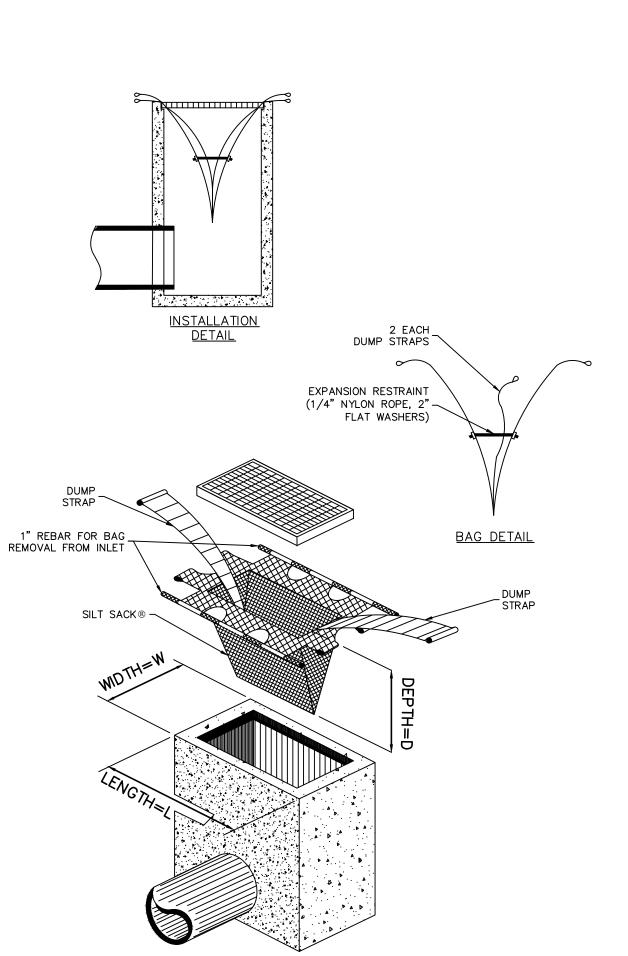

INLET SEDIMENT CONTROL DEVICE

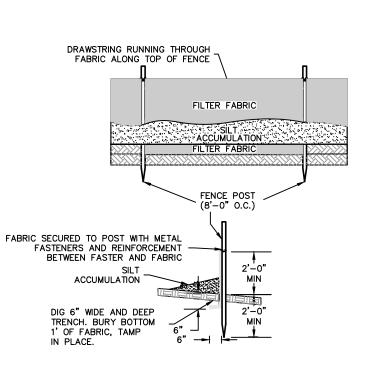



SILT FENCE NOT TO SCALE

# PROCEDURES FOR SOIL COMPACTION MITIGATION

PROCEDURES SHALL BE USED TO MITIGATE EXCESSIVE SOIL COMPACTION PRIOR TO PLACEMENT OF TOPSOIL AND ESTABLISHMENT OF PERMANENT VEGETATIVE COVER.

RESTORATION OF COMPACTED SOILS SHALL BE THROUGH DEEP SCARIFICATION/TILLAGE (6" MINIMUM DEPTH) WHERE THERE IS NO DANGER TO UNDERGROUND UTILITIES (CABLES, IRRIGATION SYSTEMS, ETC.). IN THE ALTERNATIVE, ANOTHER METHOD AS SPECIFIED BY A NEW JERSEY LICENSED PROFESSIONAL ENGINEER MAYBE SUBSTITUTED SUBJECT TO DISTRICT APPROVAL.

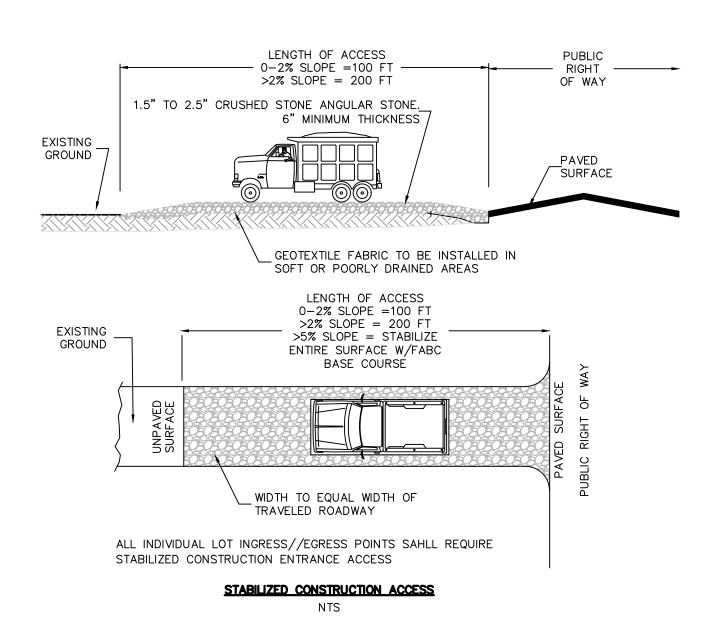

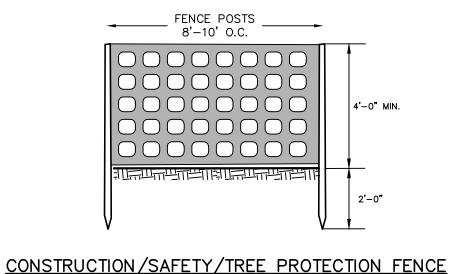





SEQUENCE OF CONSTRUCTION	_
<ol> <li>NOTIFY THE TOWN &amp; SOIL CONSERVATION DISTRICT IN WRITING 72 HOURS IN ADVANCE OF WORK.</li> </ol>	3 DAYS NOTICE
2. INSTALL SILT FENCE 3. INSTALL STABILIZED CONSTRUCTION ACCESS	1 DAY 1 DAY
4. DEMOLITION & SITE PREPARATION	1 MONTH
5. BEGIN BUILDING RENOVATION 6. TOPSOIL & MATERIAL STOCKPILING	6 MONTHS 1 DAY
7. ROUGH GRADE SITE	1 WEEK
8. CONSTRUCT UNDERGROUND UTILITIES 9. CONSTRUCT CURB AND SIDEWALKS	3 DAYS 2 WEEKS
O. CONSTRUCT SUBBASE & STABILIZED BASE COURSE	1 WEEK
1. SCARIFY SUBSOIL IN LANDSCAPED AREAS TO A MINIMUM DEPTH OF 6" TO MITIGATE SOIL COMPACTION	1 DAY
INSTALL FINAL LANDSCAPING & STABILIZATION     CONSTRUCT ROADWAY TOP COURSE UPON	1 WEEK
COMPLETION OF BUILDING CONSTRUCTION	2 DAYS


1 DAY


COMPLETION OF BUILDING CONSTRUCTION 14. REMOVE TEMPORARY SEDIMENT CONTROL MEASURES

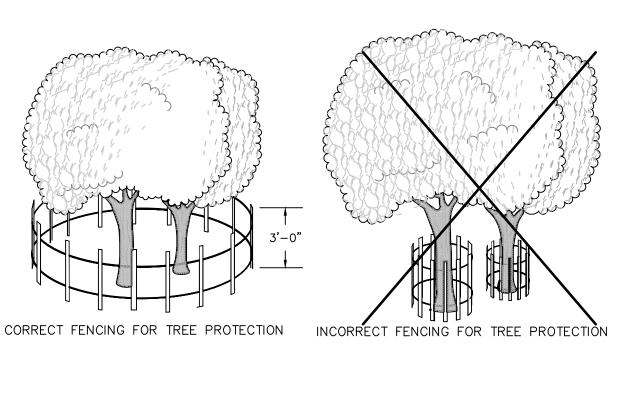


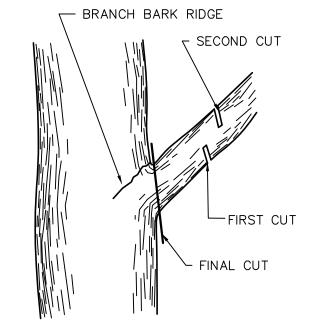


TREE PROTECTION

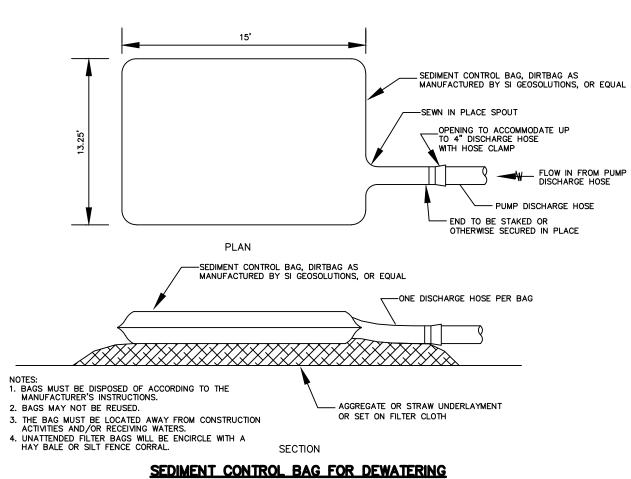

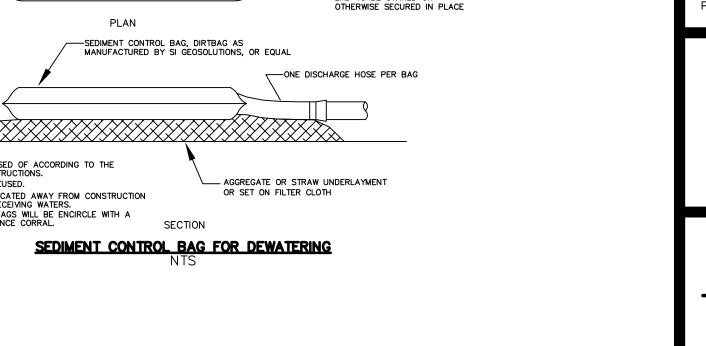

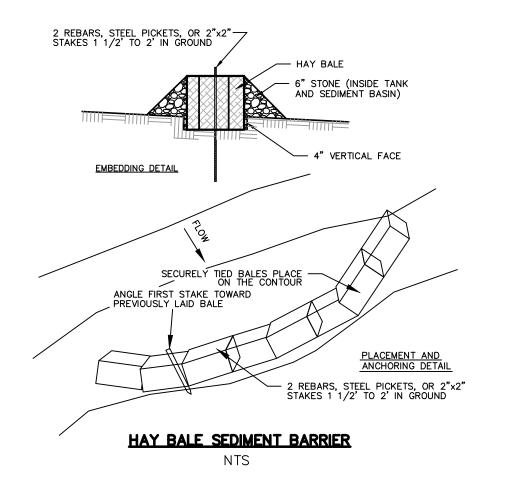

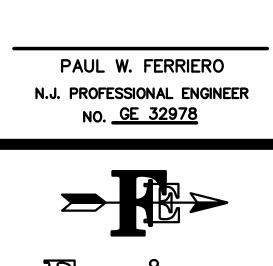

FIELD BOOK:

\201051\201051\_BASEMAP




180 MAIN STREET P.O. BOX 571 CHESTER, NEW JERSEY 07930 908-879-6209 CERTIFICATE OF AUTHORIZATION 24GA27935400


SOIL EROSION & SEDIMENT CONTROL **DETAILS** 


> TAX LOT 6.01 BLOCK 1201 TOWN OF DOVER MORRIS COUNTY **NEW JERSEY**

SHEET			
7	OF	9	

PROJECT NO 9/16/21 201051 EVISION:

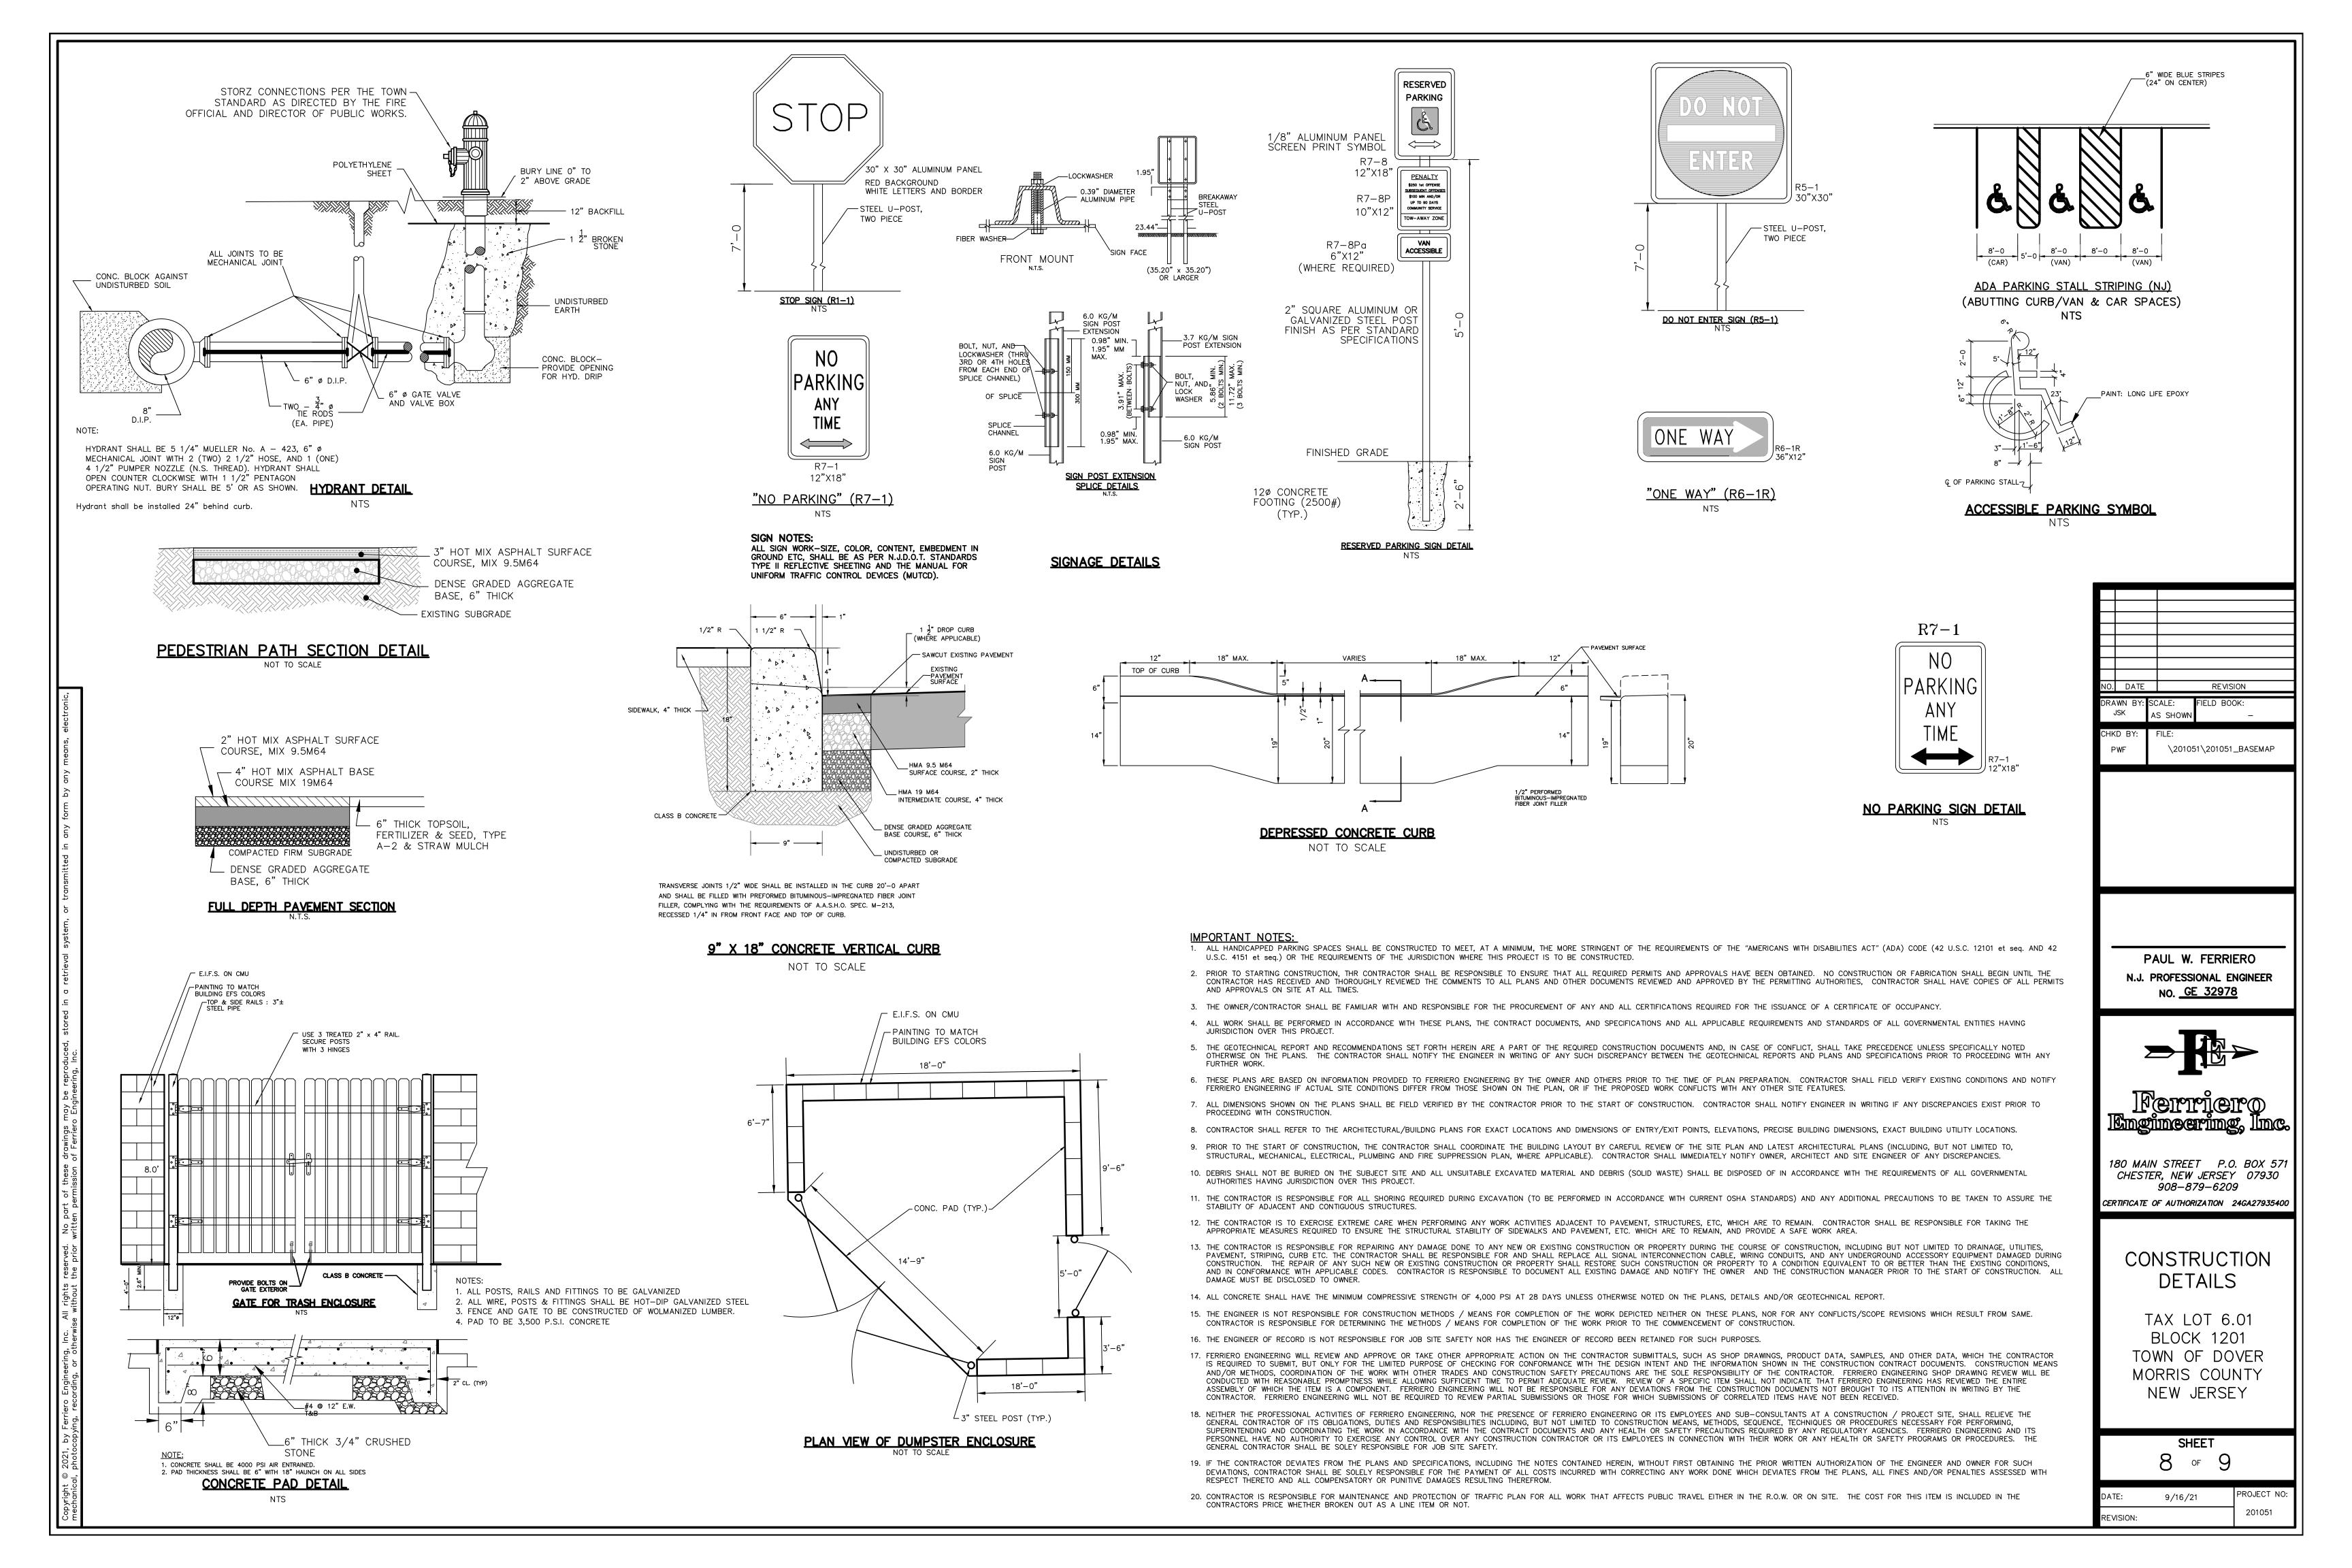

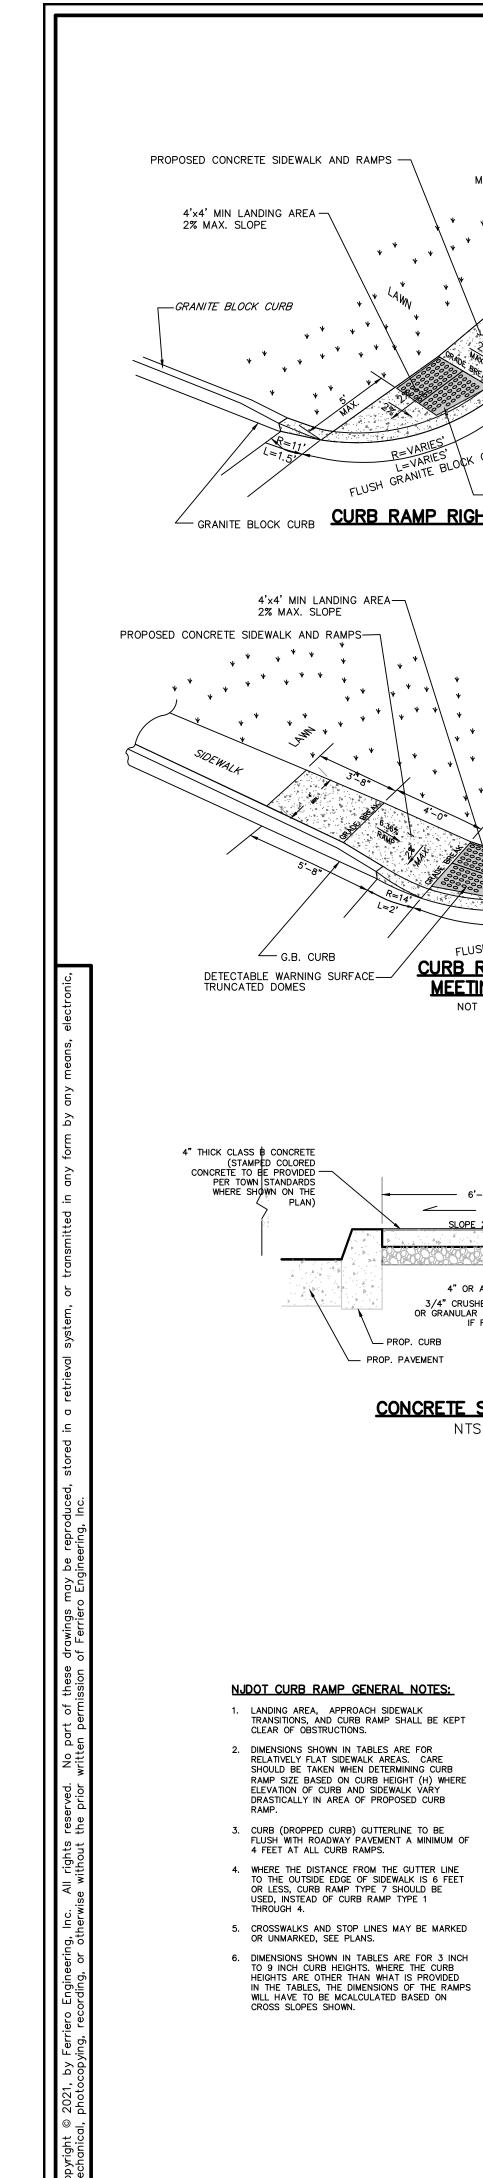

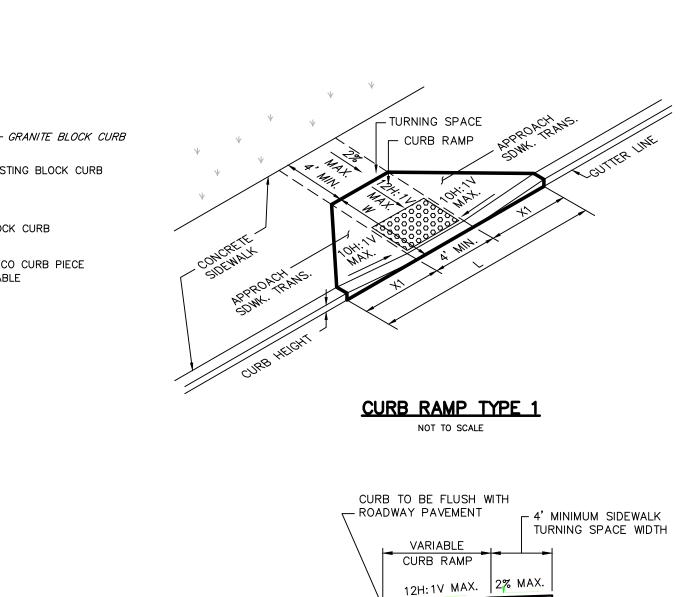



SECTION THROUGH NJDOT CURB RAMP TYPE 1


# CURB RAMP TYPE 1 .090 DEG POINTS .045 (1.1) HIGH (TYP) \_ 4'x4' MIN LANDING AREA 2% MAX. SLOPE

NJDOT CURB RAMP TREATMENT
AT CURVES

NOT TO SCALE

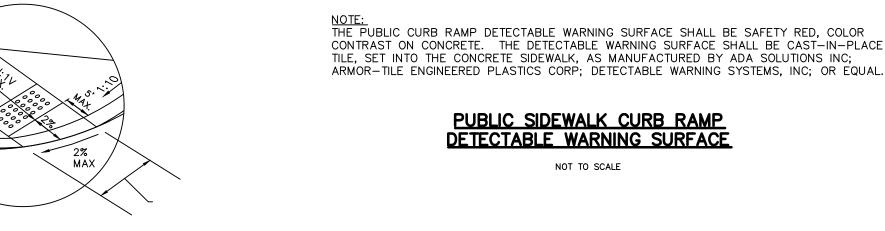

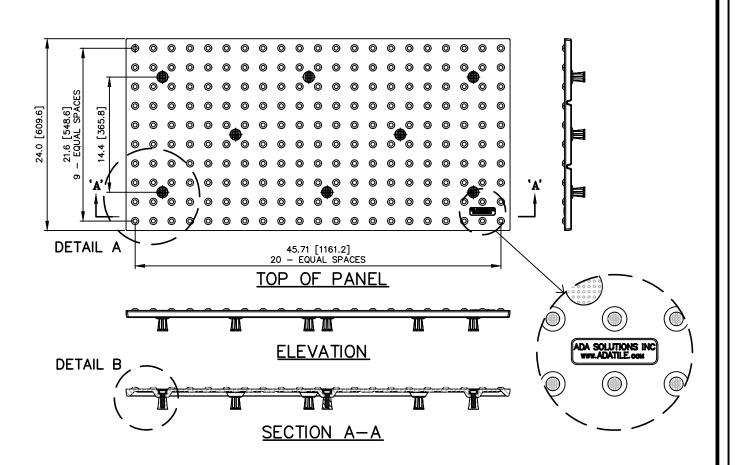

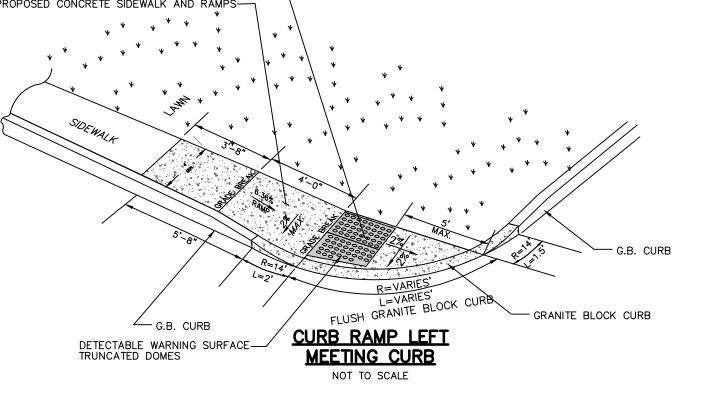

MEET\_EXISTING SIDEWALK-

±6" MEET EXISTING BLOCK CURB


- GRANITE BLOCK CURB

WHERE APPLICABLE

- PROPOSED GRANITE BLOCK CURB


DETECTABLE WARNING SURFACE TRUNCATED DOMES


PROPOSED P-ECO CURB PIECE

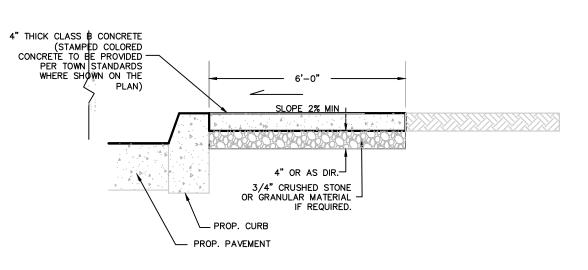

CONCRETE SIDEWALK NTS

# '-6" SDWK. 1'-6" FH=CURB HEIGHT

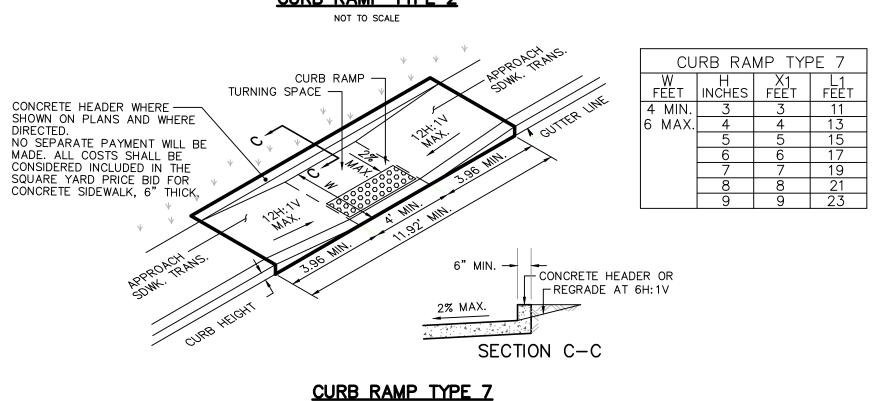

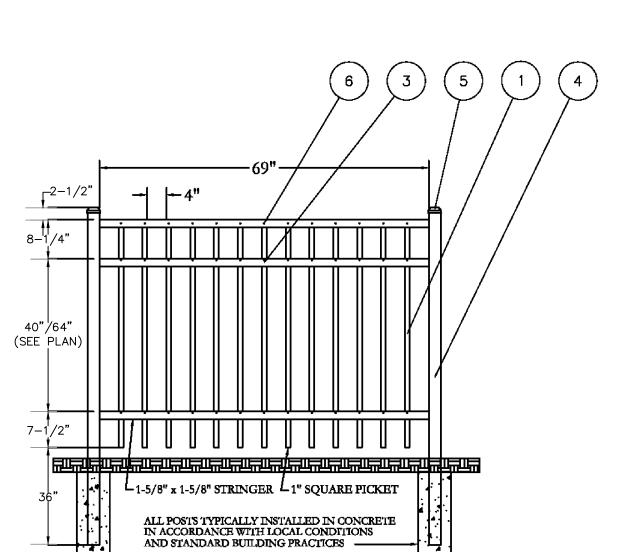



CAP COVER

— HEX HEAD BOLTS &

WASHER 8 - PL.

FINISHED PAVEMENT

9.5 M 64 SURFACE COURSE, 2" THICK

SURFACE HOT MIX ASPHALT -

<u>DETAIL A</u> <u>FIELD DOT 7 DOME LAYOUT</u>

1 FOOT FACE OF CURB OR 1 FOOT MINIMUM FROM EDGE OF THE EXISTING PAVEMENT

-EXISTING PAVEMENT PRIOR TO BASE REPAIR

FOR A MAXIMUM DIFFERENCE OF 2-INCHES

- EXISTING PAVEMENT SURFACE

THE EDGE JOINT,

TYPICAL HALF-SECTION SHOWING MILLING ADJACENT
BASE REPAIR SECTION

(LOCATION VARIES)

NOT TO SCALE

BASE REPAIR TO INCLUDE HOT MIX ASPHALT BASE - COURSE, 19 M 64, 6 INCH MINIMUM AND DENSE

GRADED AGGREGATE BASE COURSE, 8 INCH MINIMUM

INCREASE DEPTH OF BASE REPAIR AS REQUIRED

VARIABLE DEPTH, 3" MAXIMUM

SAW CUT EXISTING PAVEMENT AND TACK COAT

MILLING, AFTER CURB CONSTRUCTION & BASE REPAIR

AS INDICATED ON THE CONSTRUCTION PLANS

NO. DATE REVISION  DRAWN BY: SCALE: FIELD BOOK: AS SHOWN —  CHKD BY: FILE:
DRAWN BY: SCALE: FIELD BOOK:  JSK AS SHOWN -  CHKD BY: FILE:
DRAWN BY: SCALE: FIELD BOOK:  JSK AS SHOWN -  CHKD BY: FILE:
DRAWN BY: SCALE: FIELD BOOK:  JSK AS SHOWN -  CHKD BY: FILE:
DRAWN BY: SCALE: FIELD BOOK:  JSK AS SHOWN -  CHKD BY: FILE:
JSK AS SHOWN - CHKD BY: FILE:
\ 0010E1\ 0010E1 DACEMAD
PWF \201051\201051_BASEMAP

PAUL W. FERRIERO N.J. PROFESSIONAL ENGINEER

NO. <u>GE 32978</u>



180 MAIN STREET P.O. BOX 571 CHESTER, NEW JERSEY 07930 908-879-6209 CERTIFICATE OF AUTHORIZATION 24GA27935400

# CONSTRUCTION **DETAILS**

TAX LOT 6.01 BLOCK 1201 TOWN OF DOVER MORRIS COUNTY NEW JERSEY

FENCE PARTS

Name

70-1/2" - 13 HOLE IND. STRINGER

1202-48 PICKET

	SHEE.	Τ	
9	OF	9	

DATE:	9/16/21	PROJECT NO:
REVISION:		201051

# ADA NOTES:

CONTRACTORS SHALL EXERCISE APPROPRIATE CARE AND PRECISION IN CONSTRUCTION OF ADA (HANDICAPPED) ACCSSIBLE COMPONENTS FOR THE SITE. THESE COMPONENTS, AS CONSTRUCTED, MUST COMPLY WITH THE NJ UNIFORM
CONSTRUCTION CODE SUBCHAPTER 7 BARRIER FREE ACCESSES. FROM PARKING SPACE, PUBLIC TRANSPORTSATION, PEDESTRIAN ACCESS, INTER-BUILDING ACCESS, TO POINTS OF ACCESSIBLE BUILDING ENTRANCE/EGREE, SHALL COMPLY WITH THESE ADA CODE REQUIREMENTS. THESE INCLUDE, BUT ARE NOT LIMITED TO

PARKING SPACES AND PARKING AISLES— SLOPE SHALL NOT EXCEED 1:48 (1/4" PER FOOT OR NOMINALLY 2.0%) IN ANY


CURB RAMPS- SLOPE SHALL NOTE EXCEED 1:12 (8.3%) FOR A MAXIMUM OF SIX (6) FEET. LANDINGS — SHALL BE PROVIDED AT EACH END OF RAMPS, SHALL PROVIDE POSITIVE DRAINAGE, AND SHALL NOT EXCEED 1:48 (1/4" PER FOOT OR NOMINALLY 2.0%) CROSS

PATH OF TRAVEL ALONG ACCESSIBLE ROUTE - SHALL PROVIDE 36 INCH OR GREATER UNOBSTRUCTED WIDTH OF TRAVEL, (CAR OVERHANGS CANNOT REDUCE THIS MINIMUM WIDTH), THE SLOPE SHALL BE NO GREATER THAN 1:20 (5.0% OR 5/8" PER FOOT) IN THE DIRECTION OF TRAVEL, AND SHALL NOT EXCEED 1:48 (1/4" PER FOOT OR NOMINALLY 2.0%) IN CROSS SLOPE. WHERE PATH OF TRAVEL WILL BE GREATER THAN 1:20 (5.0%), AN ADA RAMP WITH A MAXIMUM SLOPE OF 1:12 (8.3%), FOR A MAXIMUM DISTANCE OF 30 FEET, SHALL BE PROVIDED. THE RAMP SHALL HAVE ADA HAND RAILS AND "LEVEL: LANDINGS ON EACH END THAT ARE CROSS SLOPED NO MORE THAN 1:48 (1/4" PER FOOT OR NOMINALLY 2.0%) FOR POSITIVE DRAINAGE.


IT IS RECOMMENDED THAT THE CONTRACTOR REVIEW THE INTENDED CONSTRUCTION WITH THE LOCAL BUILDING CODE OFFICIAL PRIOR TO COMMENCING WORK.



### CURB RAMP DETAILS NOT TO SCALE

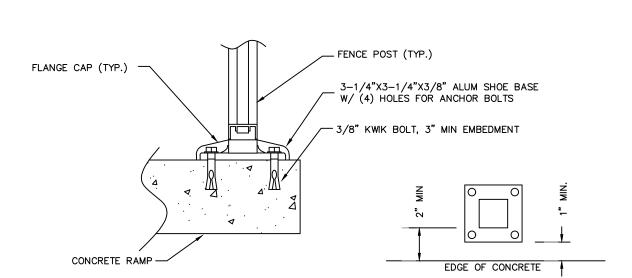

POST ANCHOR

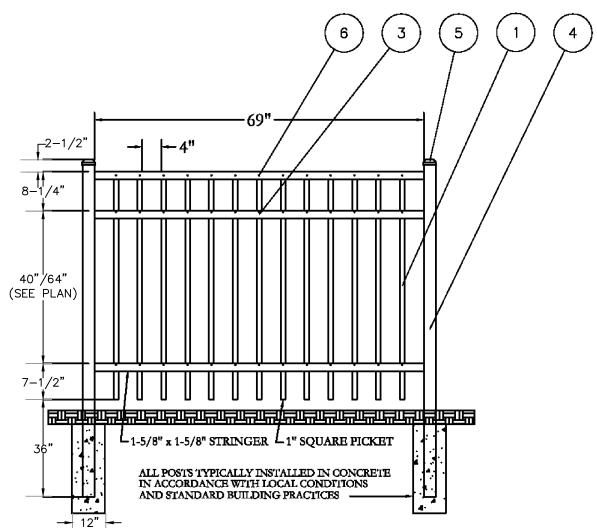

NOTES:	
PROPOSED FENCING SHALL BE BLACK INDUSTRIAL FENCE STYLE #202 AS MANUFACTURED BY JERITH	ALUMINUM FENCE
MANUFÄCTURING CO,, INC, PHILADELPHIA, PA, OR EQUIV.	NOT TO SCALE